

SULIT



**KEMENTERIAN PENDIDIKAN TINGGI
JABATAN PENDIDIKAN POLITEKNIK DAN KOLEJ KOMUNITI**

**BAHAGIAN PEPERIKSAAN DAN PENILAIAN
JABATAN PENDIDIKAN POLITEKNIK DAN KOLEJ KOMUNITI
KEMENTERIAN PENDIDIKAN TINGGI**

JABATAN KEJURUTERAAN AWAM

PEPERIKSAAN AKHIR

SESI II : 2022/2023

DCQ10043 : BUILDING WORKS MEASUREMENT 1

**TARIKH : 13 JUN 2023
MASA : 8.30 PG – 10.30 PG (2 JAM)**

Kertas ini mengandungi **LAPAN (8)** halaman bercetak.

Bahagian A: Subjektif (2 soalan)

Bahagian B: Subjektif (4 soalan)

Dokumen sokongan yang disertakan : Lampiran Lukisan, Malaysian Standard Method of Measurement of Building Works, Kertas Dimensa & Kertas Billing.

JANGAN BUKA KERTAS SOALANINI SEHINGGA DIARAHKAN

(CLO yang tertera hanya sebagai rujukan)

SULIT

SECTION A : 50 MARKS
BAHAGIAN A : 50 MARKAH**INSTRUCTION:**

This section consists of **TWO (2)** structured questions. Answer **ALL** questions.

ARAHAN :

*Bahagian ini mengandungi **DUA (2)** soalan berstruktur. Jawab semua soalan.*

QUESTION 1**SOALAN 1**

- CLO1 (a) Explain **FIVE (5)** importances of Bill of Quantities (BQ) in a construction project.

*Terangkan **LIMA (5)** fungsi Senarai Kuantiti dalam projek pembinaan.*

[10 marks]

[10 markah]

- CLO1 (b) Preliminaries is a group of items necessary for a contractor to complete a project. Describe **FIVE (5)** importances of preliminary work in the construction industry.

*Kerja awalan adalah satu kumpulan item yang diperlukan oleh kontraktor untuk menyiapkan projek. Terangkan **LIMA (5)** kepentingan kerja-kerja awalan dalam industri pembinaan.*

[15 marks]

[15 markah]

QUESTION 2***SOALAN 2***

- CLO1 (a) Interpret **FIVE (5)** contents of the Standard Method of Measurement 2 (SMM2) in Section A – General Rules.

*Terjemahkan **LIMA (5)** kandungan Kaedah Pengukuran Standard 2 (SMM2) dalam Seksyen A – Peraturan Umum.*

[10 marks]

[10 markah]

Table A2(b) : Schedule of Column Stump

Jadual A2(b) : Jadual Tiang Tunggal

Types / Jenis	C1	C2
Size of column stump <i>Saiz tiang tunggal</i>	250mm x 250mm x 1450mm	400mm x 400mm x 1450mm
Nos of column stump <i>Bilangan tiang tunggal</i>	450	120

- Notes : used Vibrated Reinforced Concrete Grade 30

- CLO1 (b) Based on Table A2(b), measure the quantity of concrete works for C1 and formwork for C1 and C2 on dimension paper.

Berdasarkan Jadual A2(b), ukur kuantiti kerja-kerja konkrit untuk C1 dan kotak acuan untuk C1 dan C2 pada kertas dimensa.

[15 marks]

[15 markah]

SECTION B : 50 MARKS
BAHAGIAN B : 50 MARKAH**INSTRUCTION:**

This section consists of **FOUR (4)** structured questions. Answer **TWO (2)** questions only.

ARAHAN :

Bahagian ini mengandungi EMPAT (4) soalan berstruktur. Jawab DUA (2) soalan sahaja.

Notes:**Nota:**

1. Taking off refers to the rules stated in the Standard Method of Measurement of Building Works Second Edition (SMM2).

Pengukuran Kuantiti hendaklah merujuk kepada peraturan Kaedah Piawaian Pengukuran Kuantiti untuk Kerja-kerja Bangunan, Edisi Ke-2 (SMM2)

2. Candidate is allowed to make any assumption if the information given in the drawing is inadequate.

Calon dibenarkan membuat andaian sekiranya maklumat yang diberikan tidak mencukupi.

QUESTION 1**SOALAN 1**

- CLO1 (a) By referring to Malaysian Standard Method of Measurement for Building Works Second Edition (SMM2), explain the classification of bar reinforcement.

Merujuk kepada Kaedah Pengukuran Piawaian Malaysia Bagi Kerja-kerja Bangunan Edisi Kedua (SMM2), terangkan pengelasan besi tetulang.

[5 marks]

[5 markah]

- CLO1 (b) Based on drawing no. **DCQ10043/WBLFF/001-002**, measure the quantity of links in column stumps.

Merujuk lukisan no. DCQ10043/WBLFF/001-002, ukur kuantiti besi pengikat di dalam tiang tunggal.

[7 marks]

[7 markah]

- CLO1 (c) Based on drawing no. **DCQ10043/WBLFF/001-002**, conclude a bill of quantities (BQ) complete with measurement main bar in pad foundation.

Merujuk lukisan no. DCQ10043/WBLFF/001-002, rumuskan satu senarai kuantiti lengkap dengan pengukuran kuantiti besi utama di dalam asas pad.

[13 marks]

[13 markah]

QUESTION 2

SOALAN 2

- CLO1 (a) By referring to Malaysian Standard Method of Measurement for Building Works Second Edition (SMM2), explain about the disposal of excavated materials by stating relevant clauses.

Merujuk kepada Kaedah Pengukuran Piawaian Malaysia Bagi Kerja-kerja Bangunan Edisi Kedua (SMM2), terangkan tentang buangan hasil korekan dengan menyatakan klausa yang berkaitan.

[5 marks]

[5 markah]

- CLO1 (b) Based on drawing no. **DCQ10043/WBLFF/003**, measure the quantity of pit excavation.

Merujuk lukisan no. DCQ10043/WBLFF/003, ukur kuantiti pengorekan lubang.

[7 marks]

[7 markah]

- CLO1 (c) Based on drawing no. **DCQ10043/WBLFF/003**, conclude a bill of quantities (BQ) complete with measurement for bar reinforcement in all column stumps.

Merujuk lukisan no. . DCQ10043/WBLFF/003, rumuskan satu senarai kuantiti lengkap dengan pengukuran kuantiti besi tetulang di dalam tiang tunggul.

[13 marks]

[13 markah]

QUESTION 3

SOALAN 3

- CLO1 (a) By referring to Malaysian Standard Method of Measurement for Building Works Second Edition (SMM2), explain the method to measure fabric reinforcement by stating the relevant clauses.

Merujuk kepada Kaedah Pengukuran Piawaian Malaysia Bagi Kerja-kerja Bangunan Edisi Kedua (SMM2), terangkan kaedah mengukur tetulang fabrik dengan menyatakan klausa yang berkaitan.

[5 marks]

[5 markah]

- CLO1 (b) Based on drawing no. **DCQ10043/WBLFF/004 - 007**, measure the quantity of wiremesh BRC No. A8 in ground floor slab (gridline 1-2/A-H only).

Merujuk lukisan no. DCQ10043/WBLFF/004 - 007, ukur kuantiti keluli tetulang fabrik BRC No. A8 pada lantai bawah (Grid 1-2/A-H sahaja).

[7 marks]

[7 markah]

- CLO1 (c) Based on drawing no. **DCQ10043/WBLFF/004 - 007**, conclude a bill of quantities (BQ) complete with measurement concrete works for column stumps.

Merujuk lukisan no. DCQ10043/WBLFF/004 - 007, rumuskan satu senarai kuantiti lengkap dengan pengukuran kuantiti kerja-kerja konkrit untuk tiang tunggal.

[13 marks]

[13 markah]

QUESTION 4

SOALAN 4

- CLO1 (a) By referring to Malaysian Standard Method of Measurement for Building Works Second Edition (SMM2), explain the classification thickness of concrete by stating the relevant clauses.

Merujuk kepada Kaedah Pengukuran Piawaian Malaysia Bagi Kerja-kerja Bangunan Edisi Kedua (SMM2), terangkan pengelasan ketebalan konkrit dengan menyatakan klausa yang berkaitan.

[5 marks]

[5 markah]

- CLO1 (b) Based on drawing no. **DCQ10043/WBLFF/001 - 002**, measure the quantity of lean concrete in pad foundation.

Merujuk lukisan no. DCQ10043/WBLFF/001 - 002, ukur kuantiti konkrit alas pada asas pad.

[7 marks]

[7 markah]

- CLO1 (c) Based on drawing no. **DCQ10043/WBLFF/001 - 002**, conclude a bill of quantities (BQ) complete with measurement concrete in ground beam.

Merujuk lukisan no. DCQ10043/WBLFF/001 - 002, rumuskan satu senarai kuantiti lengkap dengan pengukuran kuantiti konkrit di dalam rasuk tanah.


[13 marks]

[13 markah]

SOALAN TAMAT

Notes :

1. All excavation works must be starting from ground level unless otherwise stated.
2. Substructure concrete shall be Vibrated Reinforced Concrete Grade 30 unless otherwise stated.
3. Concrete cover for pad footing, column stump, and ground beam shall be 25mm thick.

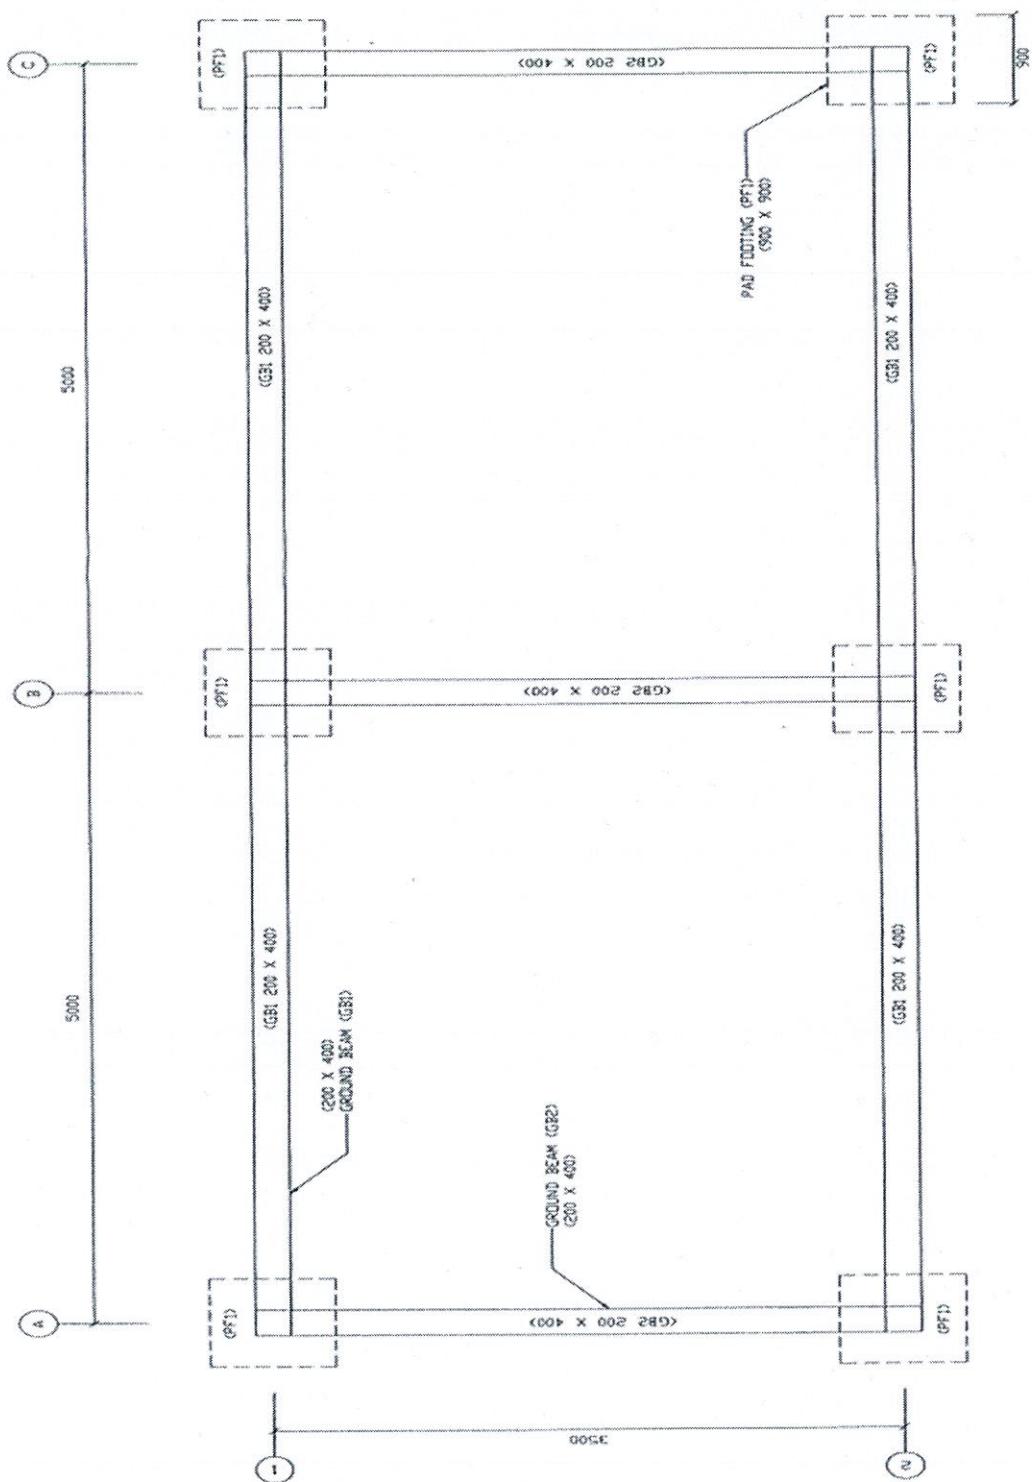

PROJECT :
PROPOSED SINGLE STOREY STOREROOM
AT LOT 81, TAMAN DESA SEJAHTERA,
KOTA TINGGI JOHOR

DRAWING TITLE :
FLOOR PLAN

DRAWING NO. :

DCQ10043/WBLFF/ 001

SCALE :
NOT TO SCALE

- Notes :
1. All excavation works must be starting from ground level unless otherwise stated.
 2. Substructure concrete shall be Vibrated Reinforced Concrete Grade 30 unless otherwise stated.
 3. Concrete cover for pad footing, column stump, and ground beam shall be 25mm thick.







PROJECT :
PROPOSED SINGLE STOREY STOREROOM
AT LOT 81, TAMAN DESA SEJAHTERA,
KOTA TINGGI JOHOR


DRAWING TITLE :
SECTION AND DETAILS

DRAWING NO :
DCQ10043/WBLFF/ 002

SCALE :
NOT TO SCALE

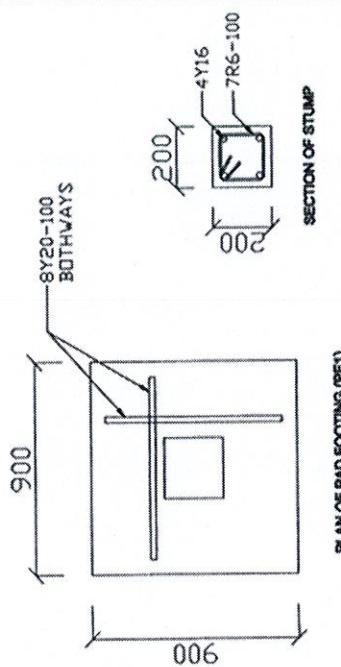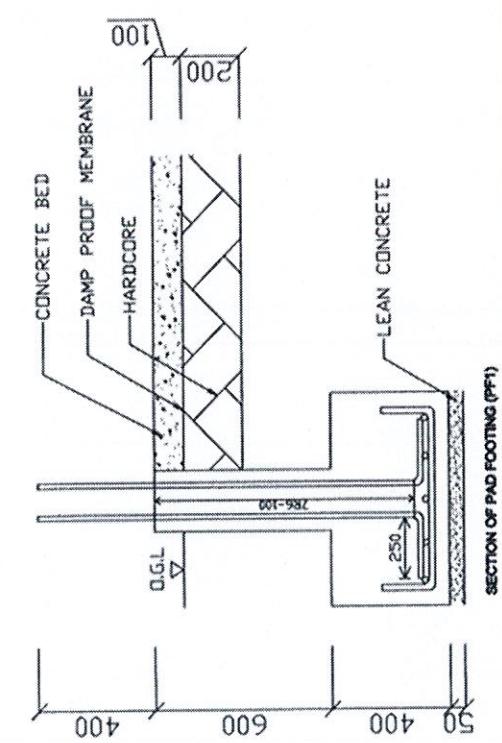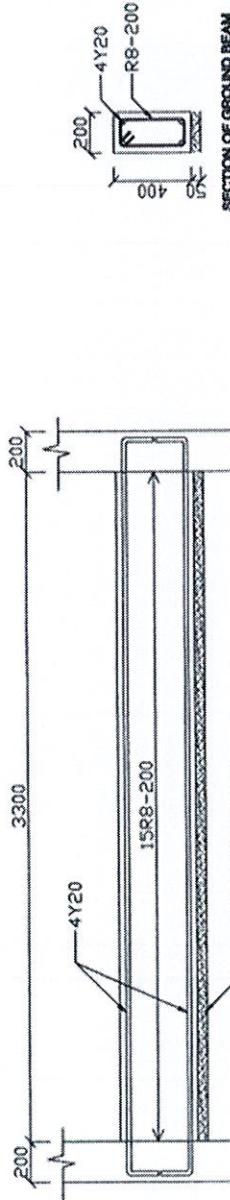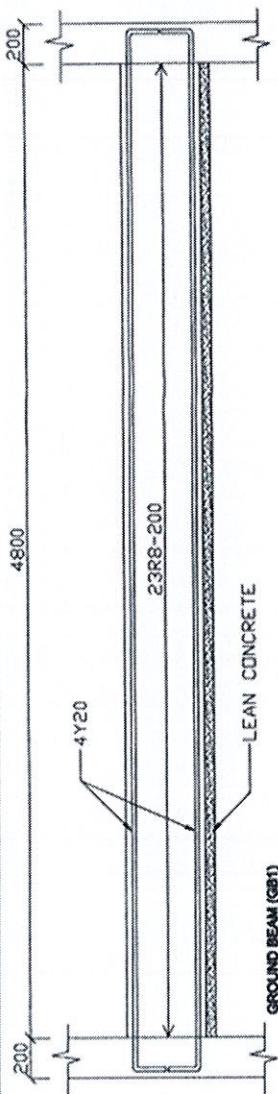

PLAN OF PAD FOOTING (PF1)

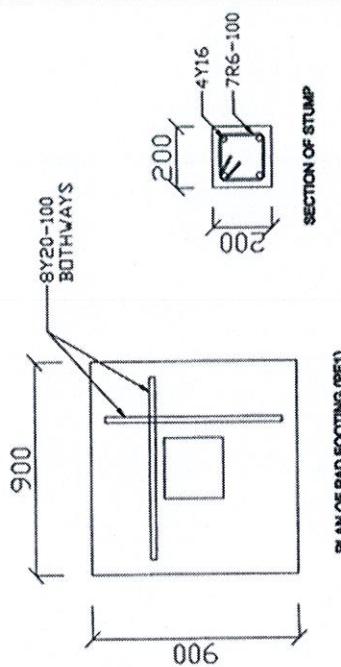

SECTION OF STUMP

- Notes :
1. Excavate topsoil 150m deep to be deposited 10.00 from site.
 2. Substructure concrete shall be Grade 35 unless otherwise stated.
 3. Lean concrete shall be Grade 15.
 4. Concrete cover shall be 45mm thick.



PROJECT :
CADANGAN MEMBINA DAN MENYIAPKAN
MAKMAL KOMPUTER DI S.K. HAKIM TEH,
TUNJANG, JITRA, KEDAH.



DRAWING TITLE :

PAD FOOTING LAYOUT PLAN


DRAWING NO. :

DCQ100043/WBLFF/003

SCALE :
NOT TO SCALE

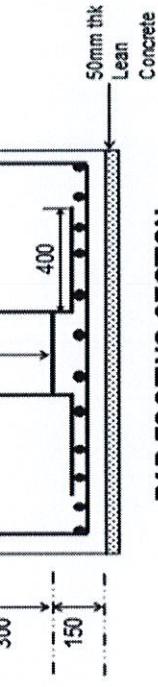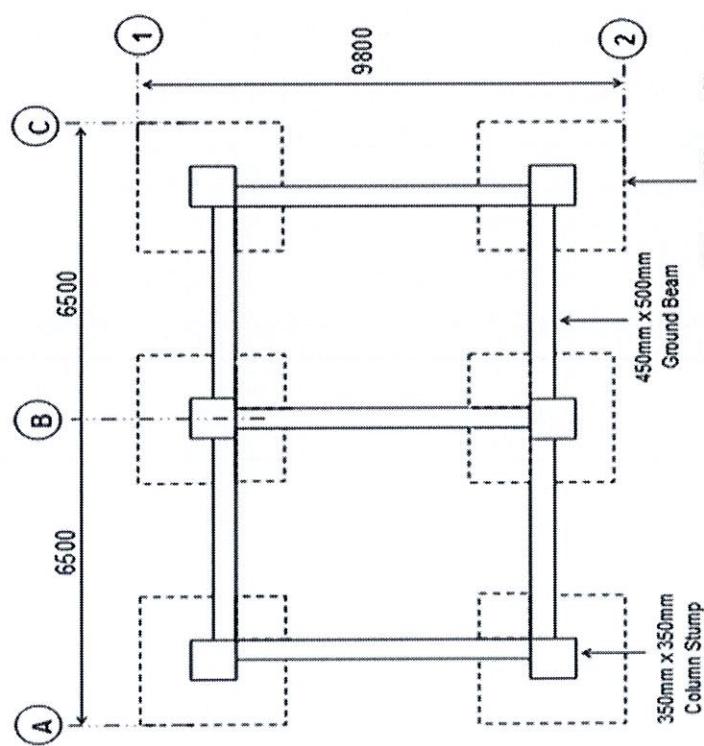

PAD FOOTING SECTION

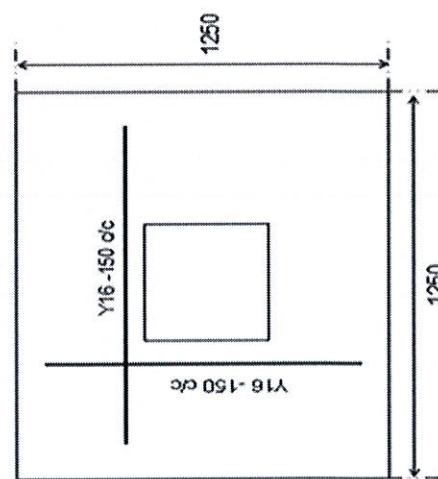

PAD FOOTING PLAN

BUNGALOW SUITE

GROUND FLOOR BEAM
SOL 1:100

GROUND
SOL: 1:10


PROJECT :
PROPOSED CONSTRUCTION OF NEW BUNGALOW
SUITE FOR TUAN ABD FARID BIN HAFIDZ AT LOT 10,
JALAN KUALA PUTATAN 2, KG. DUMPIL, 88210
KOTA KINABALU, SABAH.



DRAWING NO :
DCQ10043/WBLFF/004

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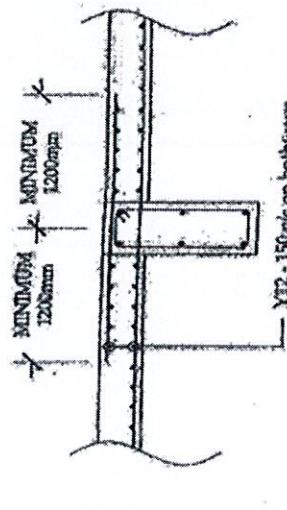
BUNGALOW SUITE

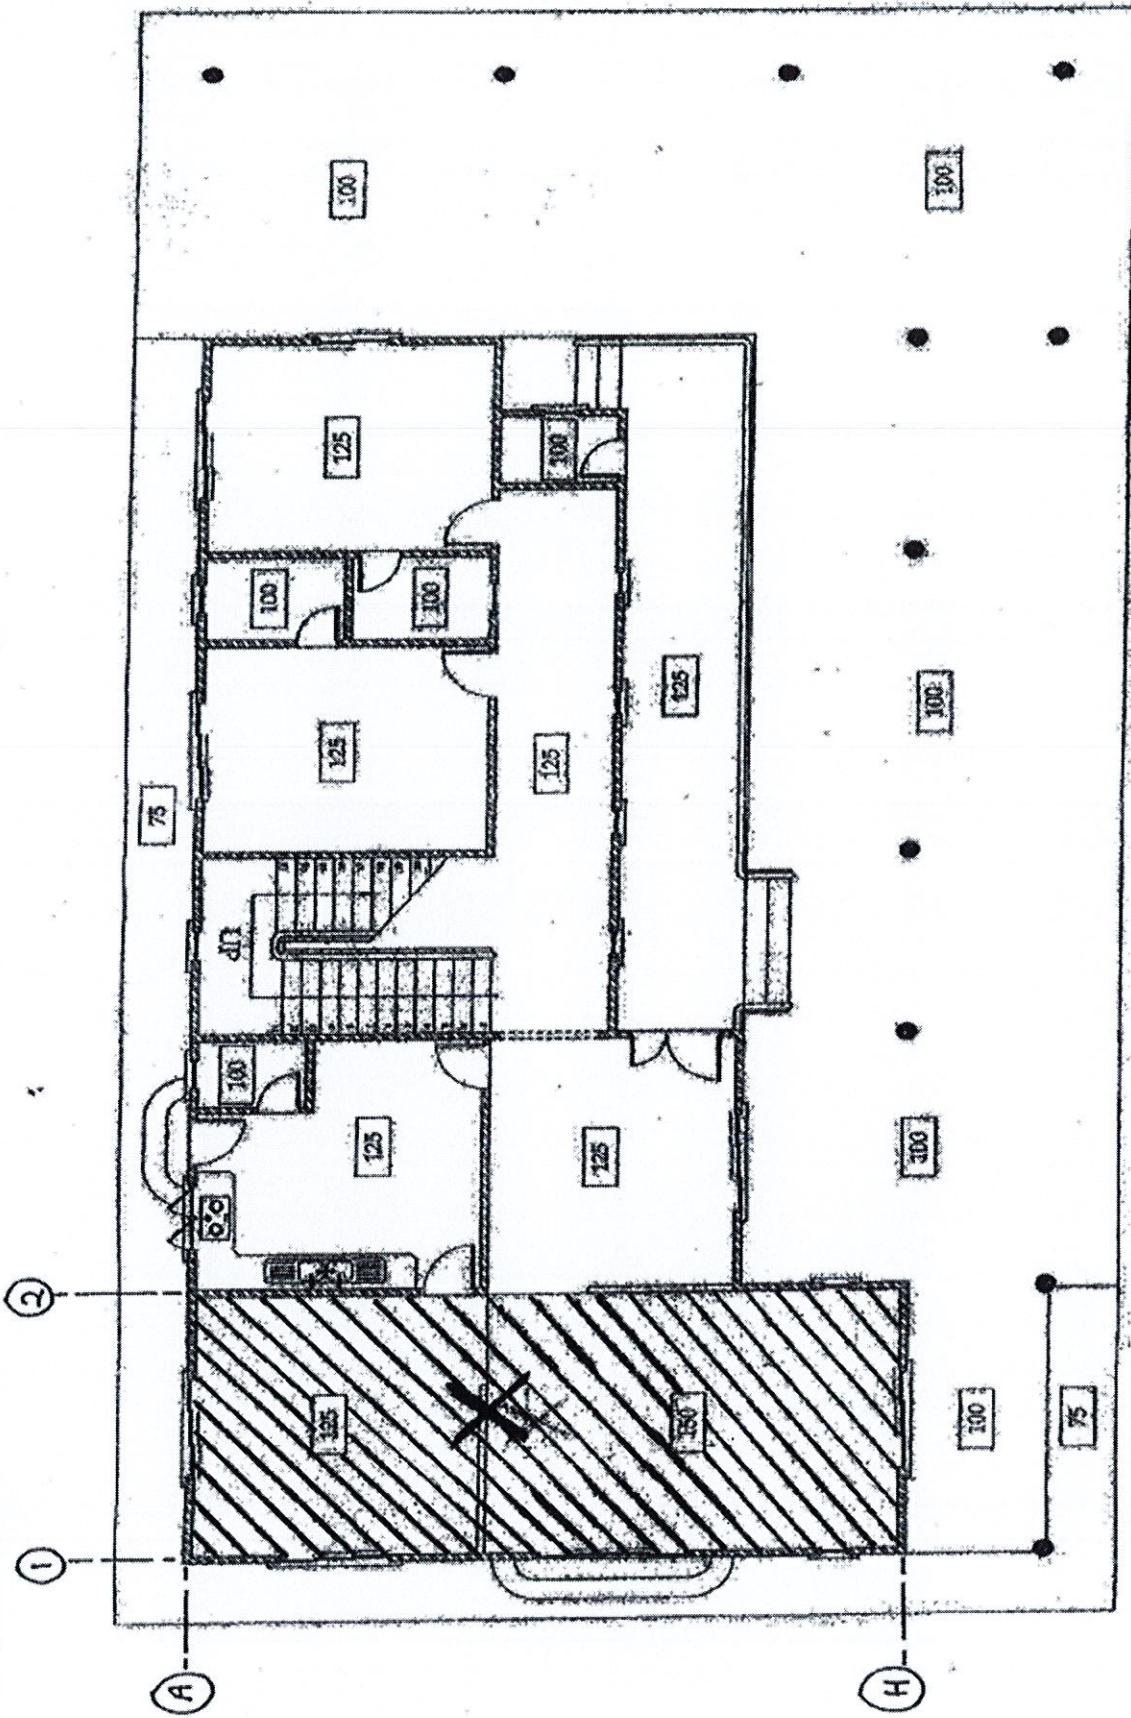

PROJECT : PROPOSED CONSTRUCTION OF NEW BUNGALOW SUITE FOR TUAN ABD FARID BIN HAFIDZ AT LOT 10, JALAN KUALA PUTATAN 2, KG. DUMPIL, 88210 KOTA KINABALU, SABAH.	SCALE : NOT TO SCALE	DRAWING TITLE : GROUND FLOOR SLAB THICKNESS	DRAWING NO : DCQ10043/WBLFF/005
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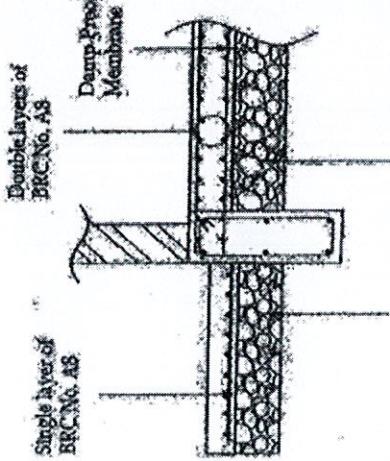
BUNGALOW SUITE

TYPE C1	rc mix (1:2:4)
COLUMN	(REINFORCED CONCRETE TO RESTORE TEAM)
SIZE	200x 350
REBAR	6x16
LINKS	R18 - 150 cft



FIRST FLOOR SLAB
Not To Scale


TYPE	C2 - rc mix(1:2:4)
COLUMN	(FROM SPANNING COLUMN TO TOWER BASE BRAM)
SIZE	4 350x350
BEAR	6716
LINKS	R10-158 4/C



GROUND FLOOR SLAB
Not To Scale


TYPE C3 - tr. mix (1:2:4)	COLUMN	STRUCTURAL COLUMN TORSION RESISTANT	SIZE	880 x 260	REBAR	6Y16	LINES	300 - 150 c/c
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TYPE C3 - ϕ . min(1:2:4)	COLUMN FRAMING/STUD BEAM HOT ROLLING	SIZE 250x 550	REBAR 6#16	LINKS HQ-15-e
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FIRST FLOOR

PIPE C2 - re min(1;2;4)	COLUMN (FROM REINFORCED BEAM TO ROOF BEAM)	
SIZE	250x 350	
REBAR	6x16	
LINKS	R10-150 dc	

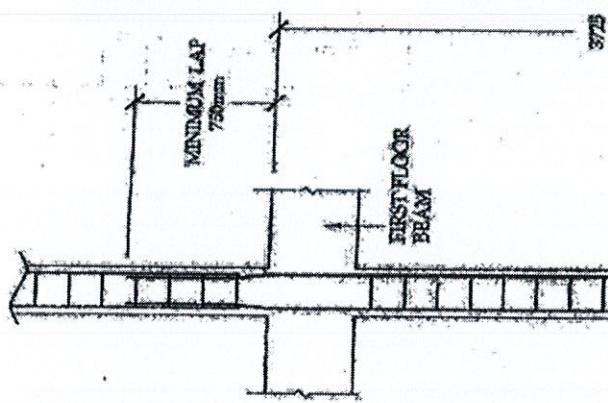

COLUMN
Notizscale

TYPE C3 - ϕ . min(1:2:4)	COLUMN FRAMING/STUD BEAM HOT ROLLING	SIZE 250x 550	REBAR 6#16	LINKS HQ-15-e
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DRAWING NO :
DCQ10043/WBLFF/006

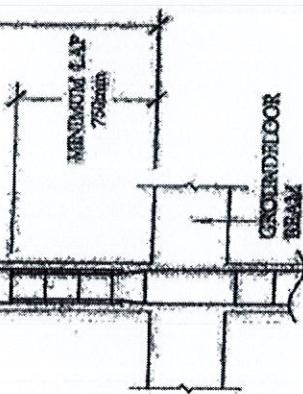AWING TITLE:

COLUMN DATES


GROUND FLOOR SLAB DETAIL

PROJECT : PROPOSED CONSTRUCTION OF NEW BUNGALOW SUITE FOR TUJAN ABD FARID BIN HAFIZZAT LOT 10,
JALAN KUALA PUTATAN 2, KG. DUMPIIL, 88210
KOTA KINABALU, SABAH.

SCALE : NOT TO SCALE

BUNGALOW SUITE

TYPE P3 - r.c mix (1:1:3)		
	PILECAP	STUMP
SIZE	1000 x 2600 x 450	350 x 350
R.C. SQUARE PILES	150mm x 150mm (18 no.)	- NIL -
REBAR	Y16-150 c/c (on bothways)	6x16
LINKS	- NIL -	R10-150 c/c

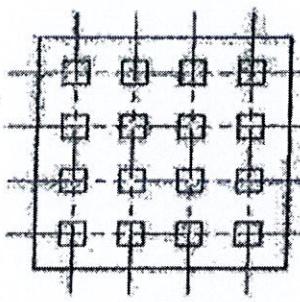


P2

TYPE P1 - r.c mix (1:1:3)		
	PILECAP	STUMP
SIZE	1000 x 1000 x 300	350 x 350
R.C. SQUARE PILES	150mm x 150mm (9 no.)	- NIL -
REBAR	Y16-150 c/c (on bothways)	6x16
LINKS	- NIL -	R10-150 c/c


TYPE P2 - r.c mix (1:1:3)		
	PILECAP	STUMP
SIZE	1500 x 1500 x 450	350x350
R.C. SQUARE PILES	150mm x 150mm (16 no.)	- NIL -
REBAR	Y16-150 c/c (on bothways)	6x16
LINKS	- NIL -	R10-150 c/c

P1

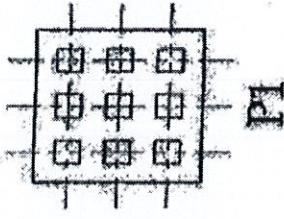


R.C. PILES POINT

DETAIL SUBSTRUCTURE
Not To Scale

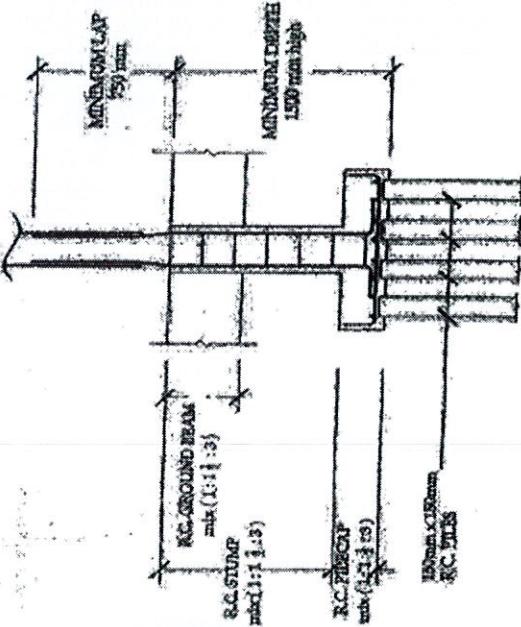

P3

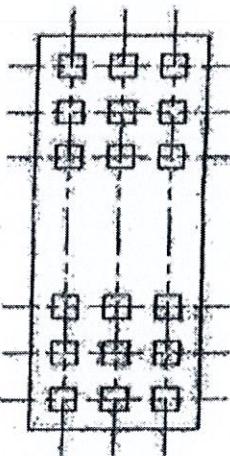

PROJECT : PROPOSED CONSTRUCTION OF NEW BUNGALOW SUITE FOR TUAN ABD FARID BIN HAFIZ AT LOT 10, JALAN KUALA PUTATAN 2, KG. DUMPLI, 88210 KOTA KINABALU, SABAH.

SCALE : NOT TO SCALE
DRAWING TITLE : DETAIL SUBSTRUCTURE

DRAWING NO : DCQ10043/WBLFF/007