

SULIT



**KEMENTERIAN PENDIDIKAN TINGGI
JABATAN PENDIDIKAN POLITEKNIK DAN KOLEJ KOMUNITI**

**BAHAGIAN PEPERIKSAAN DAN PENILAIAN
JABATAN PENDIDIKAN POLITEKNIK DAN KOLEJ KOMUNITI
KEMENTERIAN PENDIDIKAN TINGGI**

JABATAN KEJURUTERAAN AWAM

**PEPERIKSAAN AKHIR
SESI I : 2024/2025**

DCQ30154: BUILDING WORKS MEASUREMENT 3

**TARIKH : 24 NOVEMBER 2024
MASA : 8.30 PAGI – 10.30 PAGI (2 JAM)**

Kertas soalan ini mengandungi **SEBELAS (11)** halaman bercetak.

Bahagian A: Subjektif (2 soalan)

Bahagian B: Subjektif (4 soalan)

Dokumen sokongan yang disertakan : Kertas Dimensa, Kertas Billing, Jadual Cut & Fill, Lukisan dan Buku SMM2.

JANGAN BUKA KERTAS SOALANINI SEHINGGA DIARAHKAN

(CLO yang tertera hanya sebagai rujukan)

SULIT

Notes:**Nota-nota:**

1. Work measurement must be based on the principles stated in the Malaysia Standard Method of Measurement of Building Works 2nd edition (SMM2).

Kerja-kerja pengukuran mestilah berasaskan prinsip-prinsip yang dinyatakan di dalam Malaysia Standard Method of Measurement of Buildings Works 2nd edition (SMM2).

2. Make assumptions when details or specifications are not provided or are unclear. All assumptions must be clearly stated in the answer scripts.

Andaian hendaklah dibuat jika spesifikasi atau perincian tidak disediakan atau kurang jelas. Semua andaian mestilah dinyatakan dengan jelas di dalam skrip jawapan.

3. Marks will be awarded for subject knowledge, clear and systematic dimension setting and the adequacy and accuracy of descriptions and dimensions.

Markah akan diberi untuk pengetahuan tentang subjek, tata atur yang sistematis, kecukupan dan ketepatan dimensi dan keterangan.

SECTION A : 50 MARKS***BAHAGIAN A : 50 MARKAH*****INSTRUCTION:**

This section consists of **TWO (2)** subjective questions. Answers **ALL** of the questions.

ARAHAN:

*Bahagian ini mengandungi **DUA (2)** soalan subjektif. Jawab **SEMUA** soalan.*

QUESTION 1***SOALAN 1***

By referring to Drawing No: **DCQ30154/FLOOR_FINISHES/01**, answer **ALL** the questions below:

*Dengan merujuk kepada Lukisan No: **DCQ30154/FLOOR_FINISHES/01**, jawab **SEMUA** soalan di bawah:*

- CLO1 (a) By referring to the SMM2, interpret Clause S.6.1 and Clause S.8 regarding the measurement of quantities for finishing work.

Dengan merujuk kepada SMM2, tafsirkan Klausu S.6.1 dan Klausu S.8 mengenai pengukuran kuantiti di dalam kerja kemasan.

[5 marks]

[5 markah]

- CLO1 (b) Prepare the quantity measurement for Internal Floor Finishes for tiling work in the bedroom for the items below:

Sediakan pengukuran kuantiti bagi Kemasan Lantai Dalam untuk kerja-kerja Jubin di Bedroom untuk item di bawah:

Item	Description	Unit
1.	Floor Finishes / Kemasan Lantai	?
2.	Skirting / Kambi	?

[10 marks]

[10 markah]

- CLO1 (c) Prepare the quantity measurement for Internal Wall Finishes in the bedroom for the items below:

Sediakan pengukuran kuantiti bagi Kemasan Dinding Dalam di Bedroom untuk item di bawah:

Item	Description	Unit
1.	Plastering	?
2.	Painting	?

[10 marks]

[10 markah]

QUESTION 2***SOALAN 2***

By referring to Drawing No: **DCQ30154/RETAINING_WALL/01**, answer **ALL** the questions below:

*Dengan merujuk kepada Lukisan No: DCQ30154/RETAINING_WALL/01, jawab **SEMUA** soalan di bawah:*

- CLO1 (a) By referring to SMM2, interpret **TWO (2)** items involved in excavation for retaining wall works.

*Dengan merujuk kepada SMM2, tafsirkan **DUA (2)** item pengukuran yang terlibat dalam kerja-kerja pengorekan dinding penahan.*

[5 marks]

[5 markah]

- CLO1 (b) Prepare the quantity measurements for the retaining wall for the items below:

Sediakan pengukuran kuantiti bagi dinding penahan untuk item di bawah:

Item	Description	Unit
1.	Concrete blinding / Konkrit alas	?
2.	Weepholes / Lubang leleh	?

[10 marks]

[10 markah]

- CLO1 (c) Prepare the quantity measurements for the retaining wall for the items below.

Sediakan pengukuran kuantiti bagi dinding penahan untuk item di bawah:

Item	Description	Unit
1.	Concrete in Wall (Stem)/ <i>Konkrit pada Dinding</i>	?
2.	Concrete in Base (Toe and Heel) / <i>Konkrit pada Asas</i>	?

[10 marks]

[10 markah]

SECTION B : 50 MARKS***BAHAGIAN B : 50 MARKAH*****INSTRUCTION:**

This section consists of **FOUR (4)** subjective questions. Answer any **TWO (2)** questions.

ARAHAN:

*Bahagian ini mengandungi **EMPAT (4)** soalan subjektif. Jawab **DUA (2)** soalan sahaja.*

QUESTION 1***SOALAN 1***

By referring to Drawing No: **DCQ30154/FURNITURE AND FITTINGS/01 - 02**, answer **ALL** the questions below:

*Dengan merujuk kepada Lukisan No: **DCQ30154/FURNITURE AND FITTINGS/01 - 02**, jawab **SEMUA** soalan di bawah:*

- CLO1 (a) Prepare the quantity measurements for the loose furniture listed below:

Sediakan pengukuran kuantiti bagi perabut yang disenaraikan di bawah:

Item	Description	Unit
1.	Discussion Table / <i>Meja Perbincangan</i>	?
2.	Students' Workstation / <i>Stesen Kerja Pelajar</i>	?

[8 marks]

[8 markah]

- CLO1 (b) Conclude a bill of quantities complete with quantity measurement for the loose furniture listed below:

Rumuskan satu senarai kuantiti lengkap dengan pengukuran kuantiti bagi perabut yang disenaraikan di bawah:

Item	Description	Unit
1.	Lecturer's Table / Meja Pensyarah	?
2.	Office Chair / Kerusi Pejabat	?

[17 marks]

[17 markah]

QUESTION 2

SOALAN 2

By referring to Drawing No: DCQ30154/EARTHWORKS/01, answer **ALL** the questions below:

*Dengan merujuk kepada Lukisan No: DCQ30154/EARTHWORKS/01, jawab **SEMUA** soalan di bawah:*

- CLO1 (a) Using the Weighted Average Excavation Method, prepare a table for the quantity measurement of cutting and filling works for grid points **B→C→D→E→F→M→L→K→J→H→B**.

*Dengan menggunakan Kaedah Pengorekan Purata Pemberatan, sediakan pengukuran kuantiti untuk kerja pengorekan dan penambakan untuk titik grid **B→C→D→E→F→M→L→K→J→H→B**.*

[8 marks]

[8 markah]

- CLO1 (b) Conclude a bill of quantities complete with the quantity measurement for cutting and filling items prepared in question 2(a).

Rumuskan satu senarai kuantiti lengkap dengan pengukuran kuantiti untuk item pengorekan dan penambakan yang disediakan pada soalan 2(a).

[17 marks]

[17 markah]

QUESTION 3

SOALAN 3

By referring to Drawing No: DCQ30154/ROADWORK/01, answer **ALL** the questions below:

*Dengan merujuk kepada Lukisan No: DCQ30154/ROADWORK/01, jawab **SEMUA** soalan di bawah:*

- CLO1 (a) Prepare the quantity measurements for the roadworks items listed below:

Sediakan pengukuran kuantiti bagi kerja jalan untuk item di bawah:

Item	Description	Unit
1.	Sub-grade layer / Lapisan atas-dasar	?
2.	Sub-base layer / Lapisan atas-jalan	?

[8 marks]

[8 markah]

- CLO1 (b) Conclude a bill of quantities complete with the quantity measurement for roadworks items listed below:

Rumuskan satu senarai kuantiti lengkap dengan pengukuran kuantiti bagi item kerja-kerja jalan yang disenaraikan di bawah:

Item	Description	Unit
1.	Binder Course / <i>Lapisan Ikat</i>	?
2.	Wearing Course / <i>Lapisan Haus</i>	?

[17 marks]

[17 markah]

QUESTION 4

SOALAN 4

By referring to Drawing No: **DCQ30154/BASEMENT/01-03**, answer **ALL** the questions below:

Dengan merujuk kepada Lukisan No: DCQ30154/BASEMENT/01-03, jawab SEMUA soalan di bawah:

CLO1

- (a) Prepare the quantity measurements for the basement items listed below:

Sediakan pengukuran kuantiti bagi item ruang bawah tanah di bawah:

Item	Description	Unit
1.	Lean Concrete under basement slab/ <i>Konkrit alas di bawah lantai bawah tanah</i>	?
2.	Hardcore under basement slab / <i>Hadkor di bawah lantai bawah tanah</i>	?

[8 marks]

[8 markah]

- CLO1 (b) Conclude a bill of quantities complete with the quantity measurement for basement items listed below:


Rumuskan satu senarai kuantiti lengkap dengan pengukuran kuantiti bagi item item ruang bawah tanah yang disenaraikan di bawah:

Item	Description	Unit
1.	Concrete in basement wall / Konkrit di dalam dinding bawah tanah	?
2.	Formwork for basement wall / Kotak acuan untuk dinding bawah tanah	?

[17 marks]

[17 markah]

SOALAN TAMAT

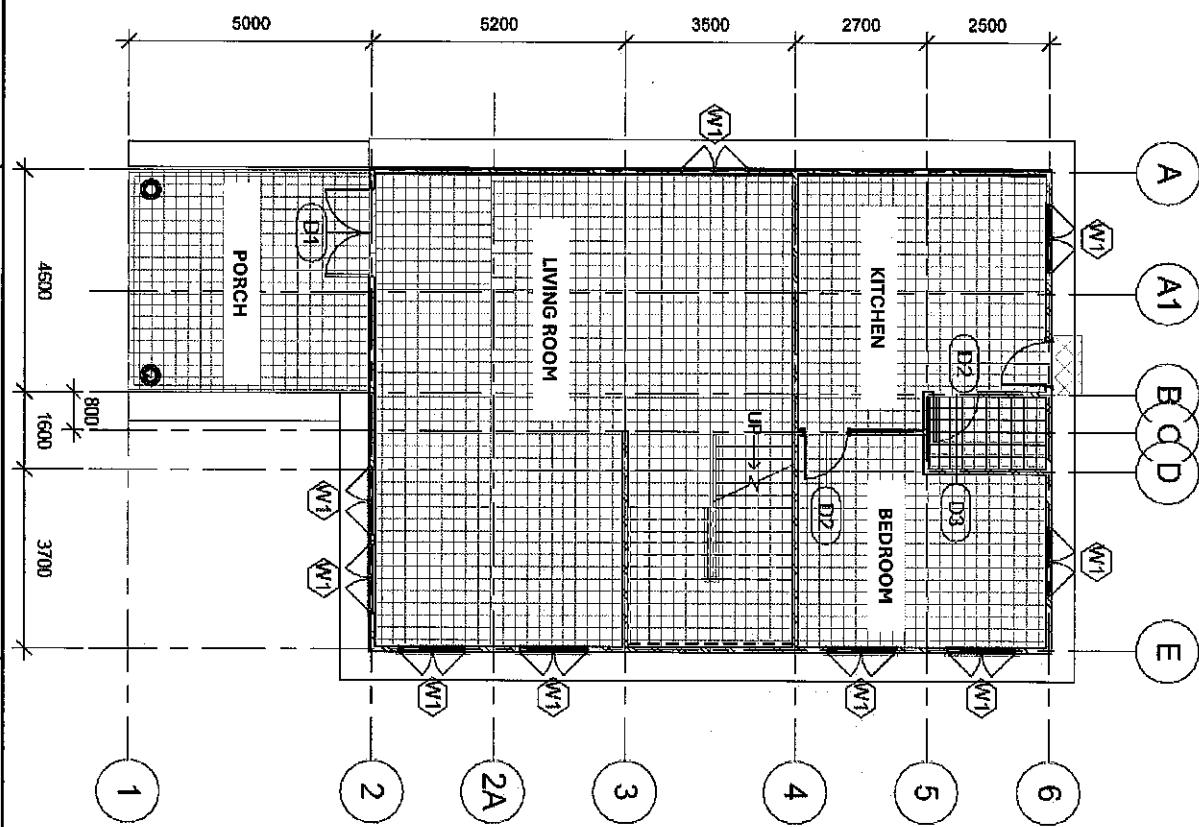

INTERNAL FINISHES DETAIL

LOCATION	FLOOR FINISHES
Living Room	300mm x 300mm x 9mm thick ceramic tiles
Kitchen	300mm x 300mm x 9mm thick non-slip ceramic tiles
Bedroom	300mm x 300mm x 9mm thick ceramic tiles
Porch	300mm x 300mm x 9mm thick homogeneous tiles

LOCATION

Bedroom	Painting: One coat alkaline resisting primer and two coats emulsion paint
	16mm Thk. (1:6) cement plaster

DOORS DETAIL

D1	Double Leaf Full Glass Door: 1800 x 2400mm
D2	Single Leaf Flush Door: 900 x 2400mm
D3	Single Leaf PVC Door: 900 x 2400mm
Drop for D1, D2 and D3	50mm

WINDOWS DETAIL

W1	Aluminium Casement Window: 1400 X 1800mm
OTHERS DETAIL	
Height of Wall	4000mm
Thickness of Wall	113mm thick
Height of Skirting	100mm

PROJECT:

CADANGAN MEMBINA DAN
MENYAPKAN SEBUAH RUMAH DI
BANDAR BENHRANG 2020


DRAWING TITLE:

FLOOR PLAN DETAILS

SUBJECT:

PREPARED BY : AA
SCALE : NTS
DATE : OGOS 2024
DRAWING NO : DCQ30154/FLOOR_FINISHES/01

BUILDING WORKS
MEASUREMENT 3

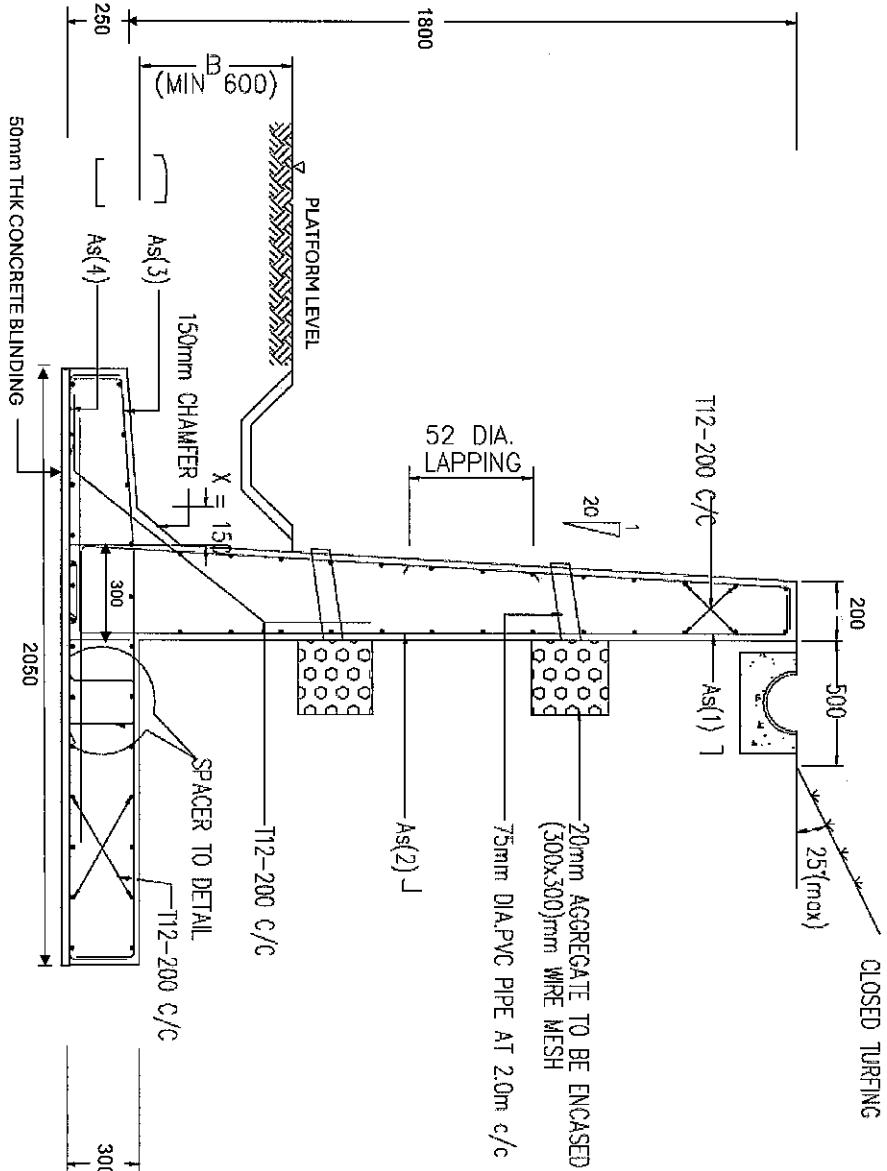

NOTES:

1. OVERALL LENGTH OF RETAINING WALL IS 3000MM
2. UNLESS OTHERWISE STATED ALL CONCRETE SHALL BE GRADE 30
3. SPACING COVER TO BE 75MM FOR REINFORCEMENT
4. ALL DIMENSIONS ARE IN MILLIMETERS UNLESS OTHERWISE STATED
5. ALL BACKFILL MATERIALS SHALL BE FROM APPROVED SUITABLE SOIL FREE FROM VEGETATION AND ROOTS
6. ALL EXISTING SERVICES SHALL BE PROTECTED DURING OPEN EXCAVATION
7. ALL TEMPORARY SLOPES SHALL BE PROTECTED FROM EROSION

TYPICAL RETAINING WALL DETAIL

POLYCC POLITEKNIK KOLEJ KOMUNITI	PROJECT: CADDANGAN MEMBINA DAN MENMARKAN KOMPLEKS BOMBA DI BANDAR SLIM RIVER, PERAK	DRAWING TITLE: RETAINING WALL DETAILS	SUBJECT: BUILDING WORKS MEASUREMENT 3
			PREPARED BY : AA SCALE : NTS DATE : OGOS 2024 DRAWING NO : DCQ30154/RETAINING_WALL/01

PROJECT:

CADANGAN MEMBINA DAN
 MENYAPKAN SEBUAH MAKMAL
 KOMPUTER

DRAWING TITLE:
 FURNITURE AND FITTINGS LAYOUT PLAN

SUBJECT:

BUILDING WORKS
 MEASUREMENT 3


PREPARED BY : AA
 SCALE : NTS
 DATE : OGOS 2024
 DRAWING NO :
 DCG30154/FURNITURE AND FITTINGS/01

21000



6000

3000


9000

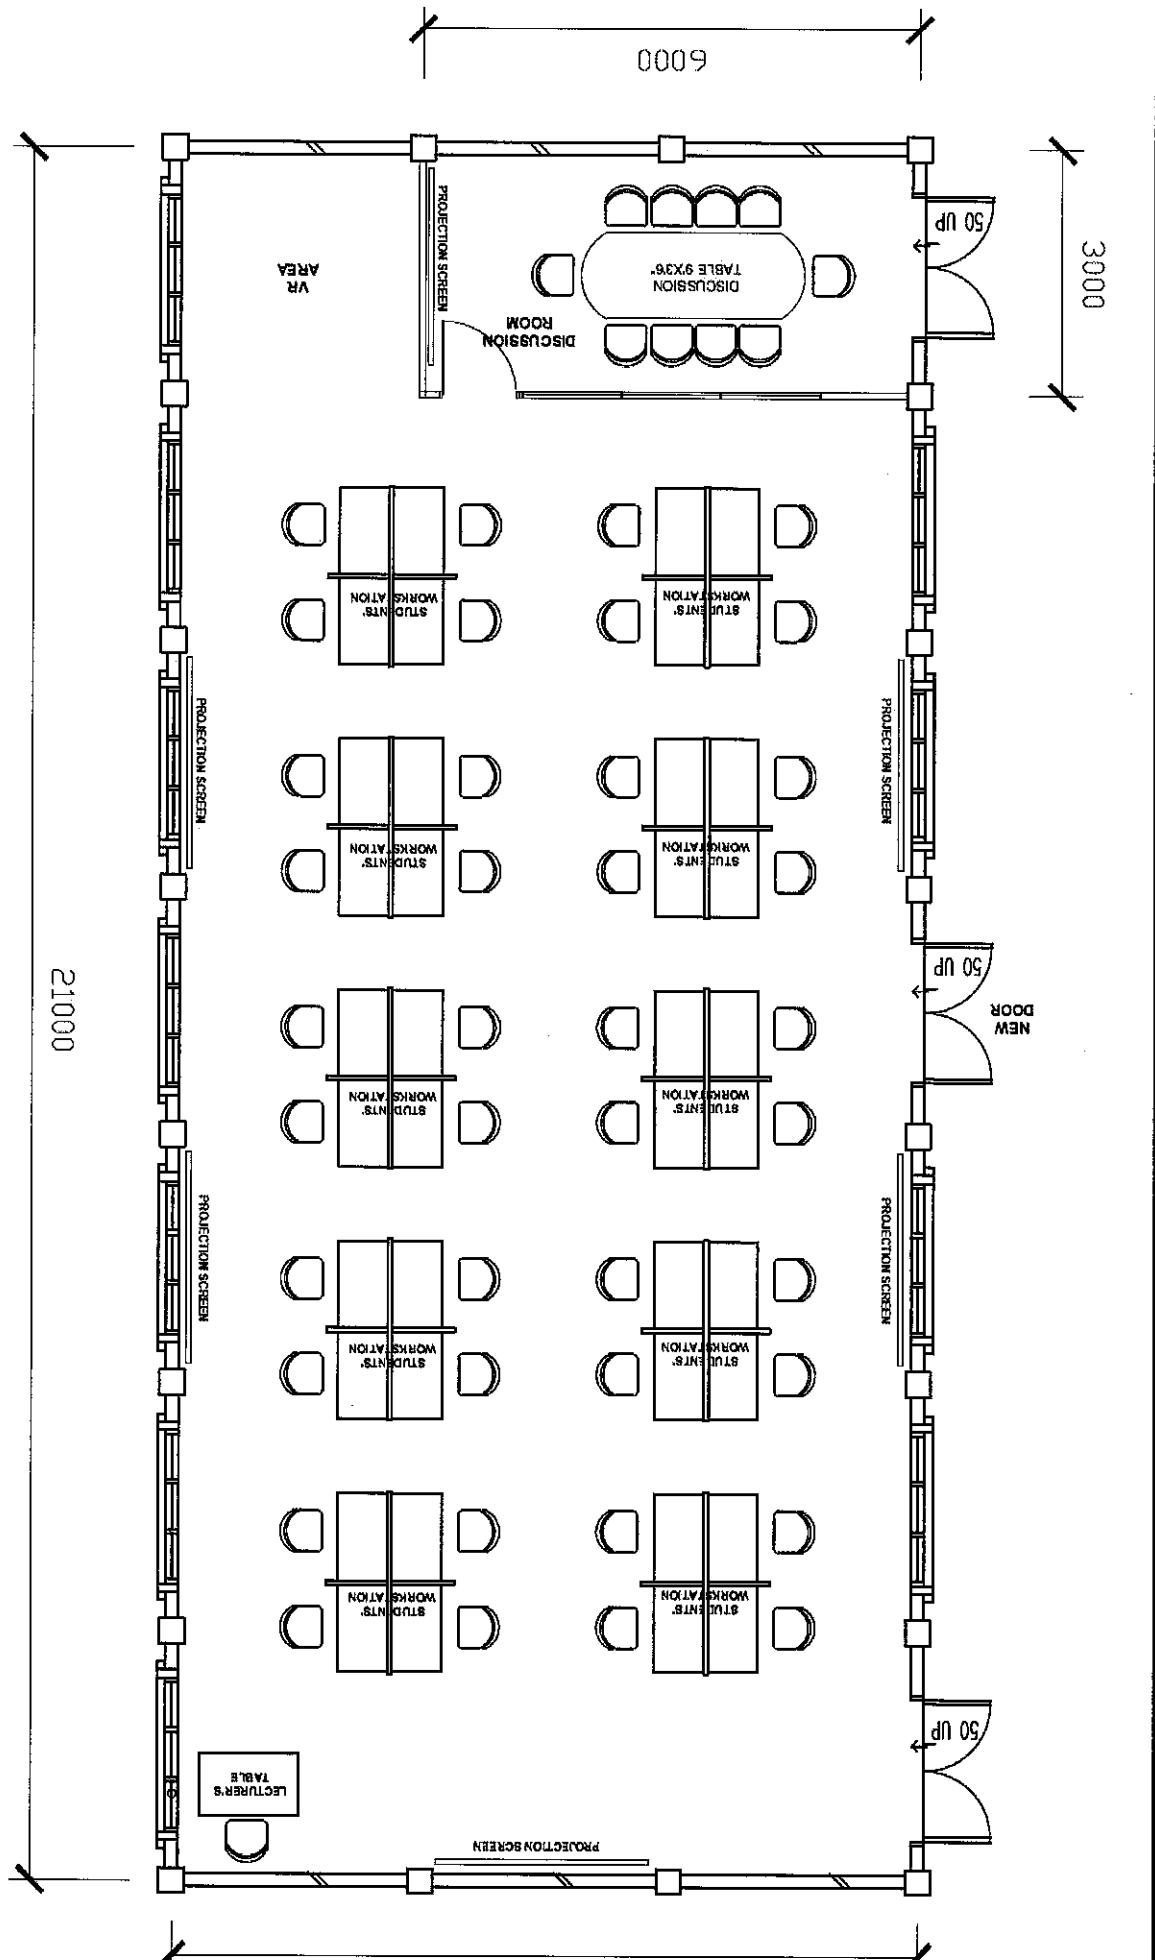


LEGEND:

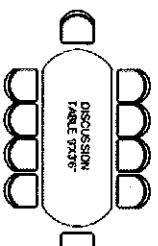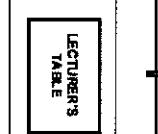FURNITURES DETAILS	
	DISCUSSION TABLE
	LECTURER'S TABLE
	OFFICE CHAIR


FURNITURES DETAILS

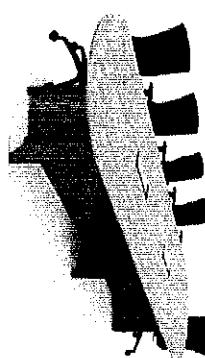DISCUSSION TABLE	
SPECIFICATION Frame: MDF board frame with 5mm thick laminate melamine ply Table Top: 40mm thick MDF board with 5mm thick laminate melamine ply Color: Gray, Maple, Boras Ash, Beach, Cherry, Acadia, White, Marble, Dark Grey, Black, Celtic Ash, Coimbra, Pale Oak, Cappuccino, Walnut Marino, Indian Ebony, Walnut	


FURNITURES DETAILS

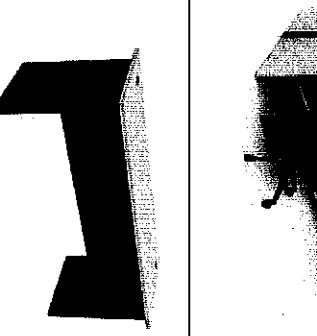LECTURER'S TABLE	
SPECIFICATION Workspace : 4-Seater Size : 300L x 1245W x 750H (mm) Table Top: 2.5cm thick worktop in high pressure compressed wood and melamine finished Partition: 3000L x 1350W x 1200H (mm) Aluminium frame partition with MFC board Leg: High pressure compressed wood and melamine finished	

FURNITURES DETAILS

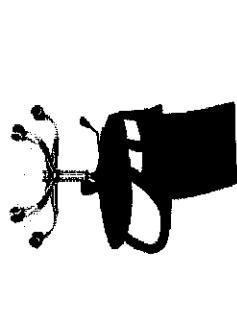OFFICE CHAIR	
SPECIFICATION Seat size: 450mm x 450mm x50mm thick pad Fabric: 100 PVC Back Rest: 450mm x 450mm x10mm polyester net Armrest: PVC Leg: Stainless steel with height adjustment and knee tilt.	

POLYCC POLITEKNIK DAN KOLEJ KOMUNITI	PROJECT: CADDANGAN MEMBINA DAN MENYAPKAN SEBUAH RUMAH DI BANDAR BENHRANG 2020	DRAWING TITLE: FURNITURE AND FITTINGS DETAILS	SUBJECT: BUILDING WORKS MEASUREMENT 3	PREPARED BY : AZIE SCALE : NTS DATE : OGOS 2024 DRAWING NO : DCQ30154/FURNITURE AND FITTINGS/02

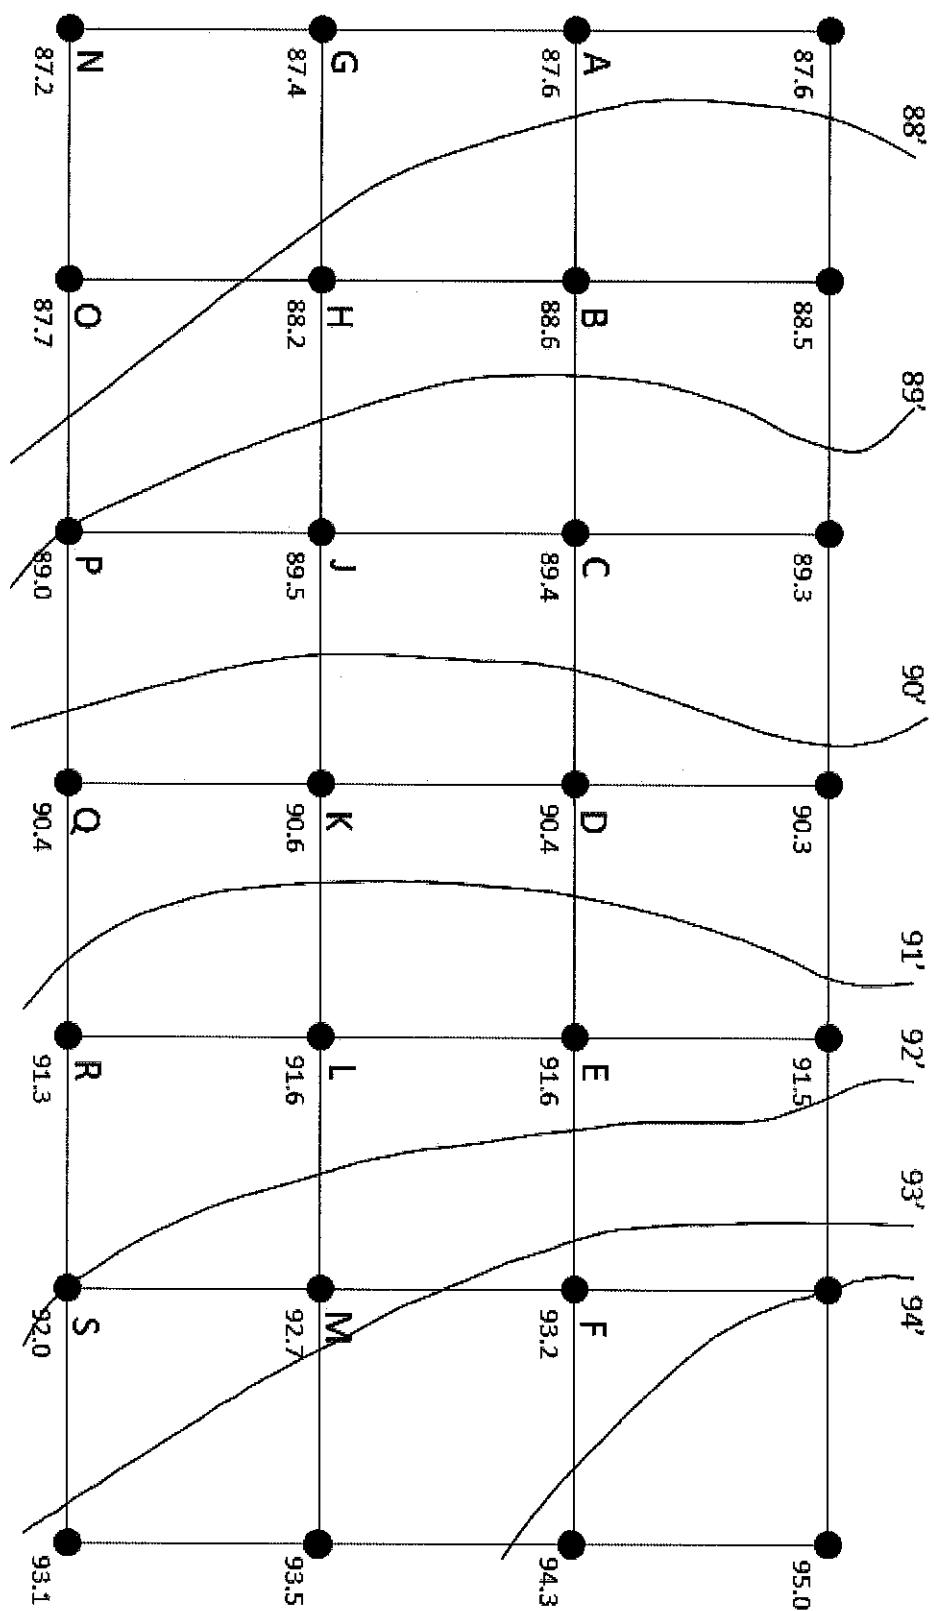


NOTE:

1. Grid size: 10.00m x 10.00m
2. Platform Level : 90.00
3. Filling: Imported suitable material

PROPOSED PREMIX ROAD LAYERS:

- 50mm THK WEARING COURSE PREMIX
- 70mm THK BINDER COURSE PREMIX
- 250mm THK CRUSHER RUN
- 100mm THK SAND BASE

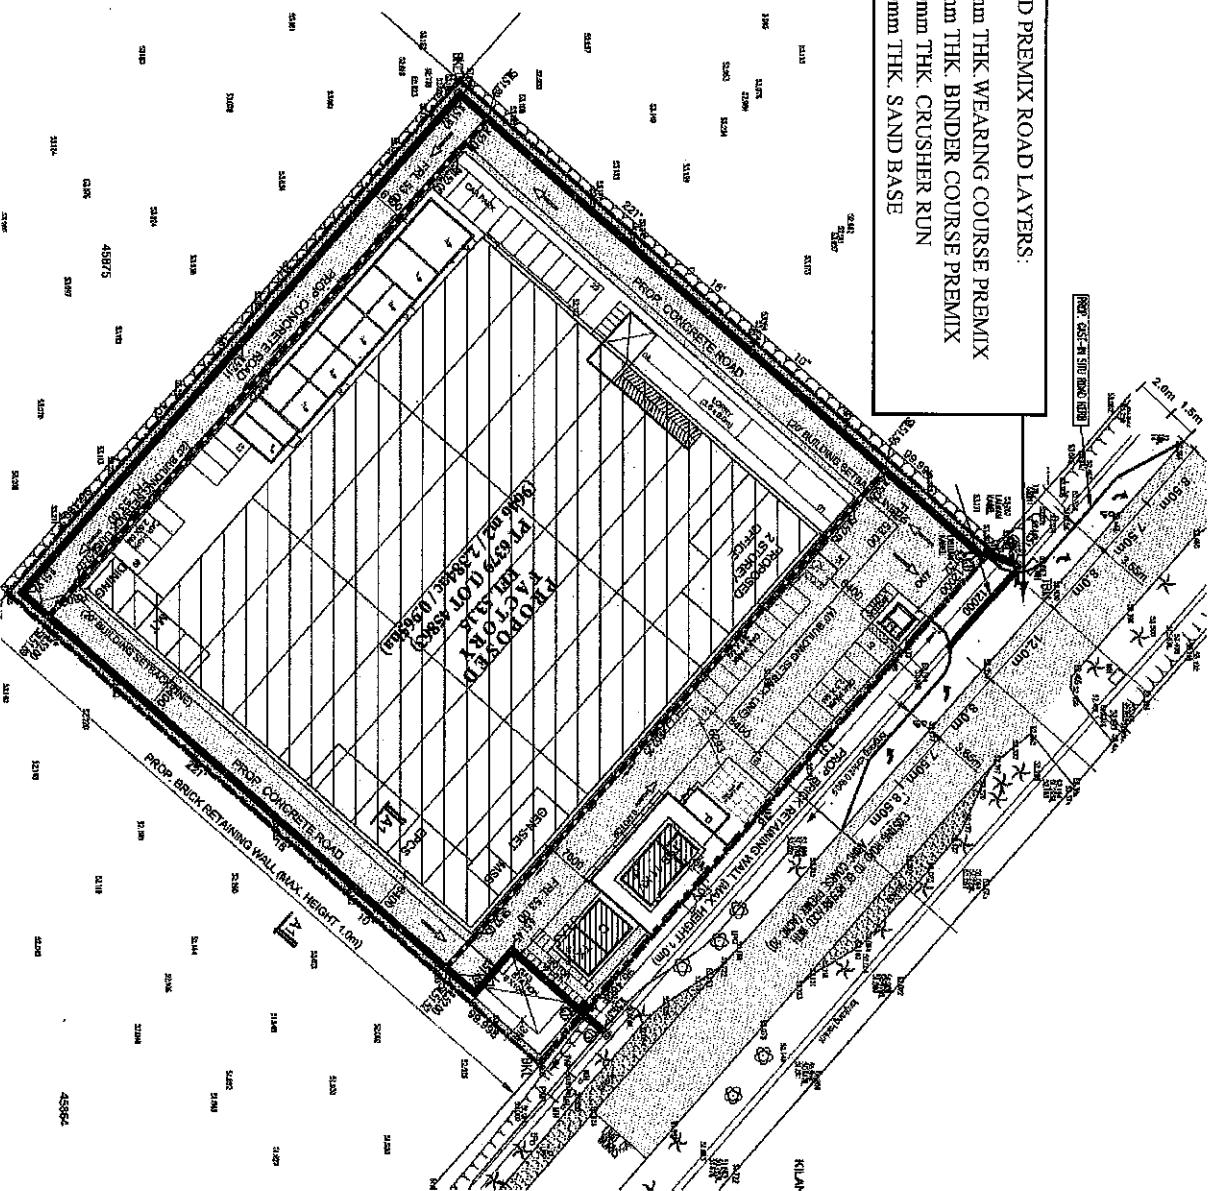

LEGENDS :-

PRLS3.00	PROPOSED FINISHED ROAD LEVEL
3.00	PROPOSED FINISHED PLATFORM LEVEL
PROPS 450MM PIPE CULVERT (CLASS 2) AS OSD 6'-1200 WITH INSPECTION SHAP 6.0m x 0.6m WITH CAST-IN-SITU CONCRETE SLAB AND OPENING 9.0m x 0.6m	PROPOSED FINISHED ROAD LEVEL
PROPOSED CAST-IN-SITU ROAD KERB OPENING 9.0m x 0.6m	PROPOSED FINISHED PLATFORM LEVEL
PROPOSED SUMP / INSPECTION SUMP OPENING 9.0m x 0.6m	PROPOSED FINISHED ROAD LEVEL

PROPOSED FINISHED ROAD LEVEL
PROPOSED FINISHED PLATFORM LEVEL
PROPS 450MM PIPE CULVERT (CLASS 2) AS OSD
6'-1200 WITH INSPECTION SHAP 6.0m x 0.6m
WITH CAST-IN-SITU CONCRETE SLAB AND
OPENING 9.0m x 0.6m

PROPOSED INVERT LEVEL	PROPOSED FINISHED ROAD LEVEL
SIL	PROPOSED FINISHED PLATFORM LEVEL
EL	PROPOSED FINISHED ROAD LEVEL
EXISTING INVERT LEVEL	PROPOSED FINISHED ROAD LEVEL
L	PROPOSED FINISHED ROAD LEVEL
PROPOSED CONCRETE ROAD	PROPOSED FINISHED ROAD LEVEL
PROPOSED PREMIX ROAD	PROPOSED FINISHED ROAD LEVEL
EXISTING ROAD TO BE RESURFACED WITH 50mm THK WEARING COURSE PREMIX (ACW50)	PROPOSED FINISHED ROAD LEVEL
PROPOSED STOP LINE	PROPOSED FINISHED ROAD LEVEL

POLYCC POLITEKNIK KOLEJ KOMUNITI	PROJECT: CADANGAN MEMBINA DAN MENYIARAKAN SEBUAH KILANG 1 TINGKAT	DRAWING TITLE: SITE PLAN	SUBJECT: BUILDING WORKS MEASUREMENT 3
		COURSE CODE: DCQ30154	PREPARED BY : AA SCALE : NTS DATE : OGOS 2024 DRAWING NO : DCQ30154/ROADWORK/01

PROJECT:

CADANGAN MEMBINA DAN
 MENYIAPKAN BANGUNAN KUARTERS
 5 TINGKAT BESERTA RUANG LETAK
 KERETA BAWAH TANAH

DRAWING TITLE:
 BASEMENT PLAN DETAILS


SUBJECT:


BUILDING WORKS
 MEASUREMENT 3

COURSE CODE: DCQ30154

PREPARED BY : AA
 SCALE : NTS
 DATE : OGOS 2024

DRAWING NO.: DCQ30154/BASEMENT/01

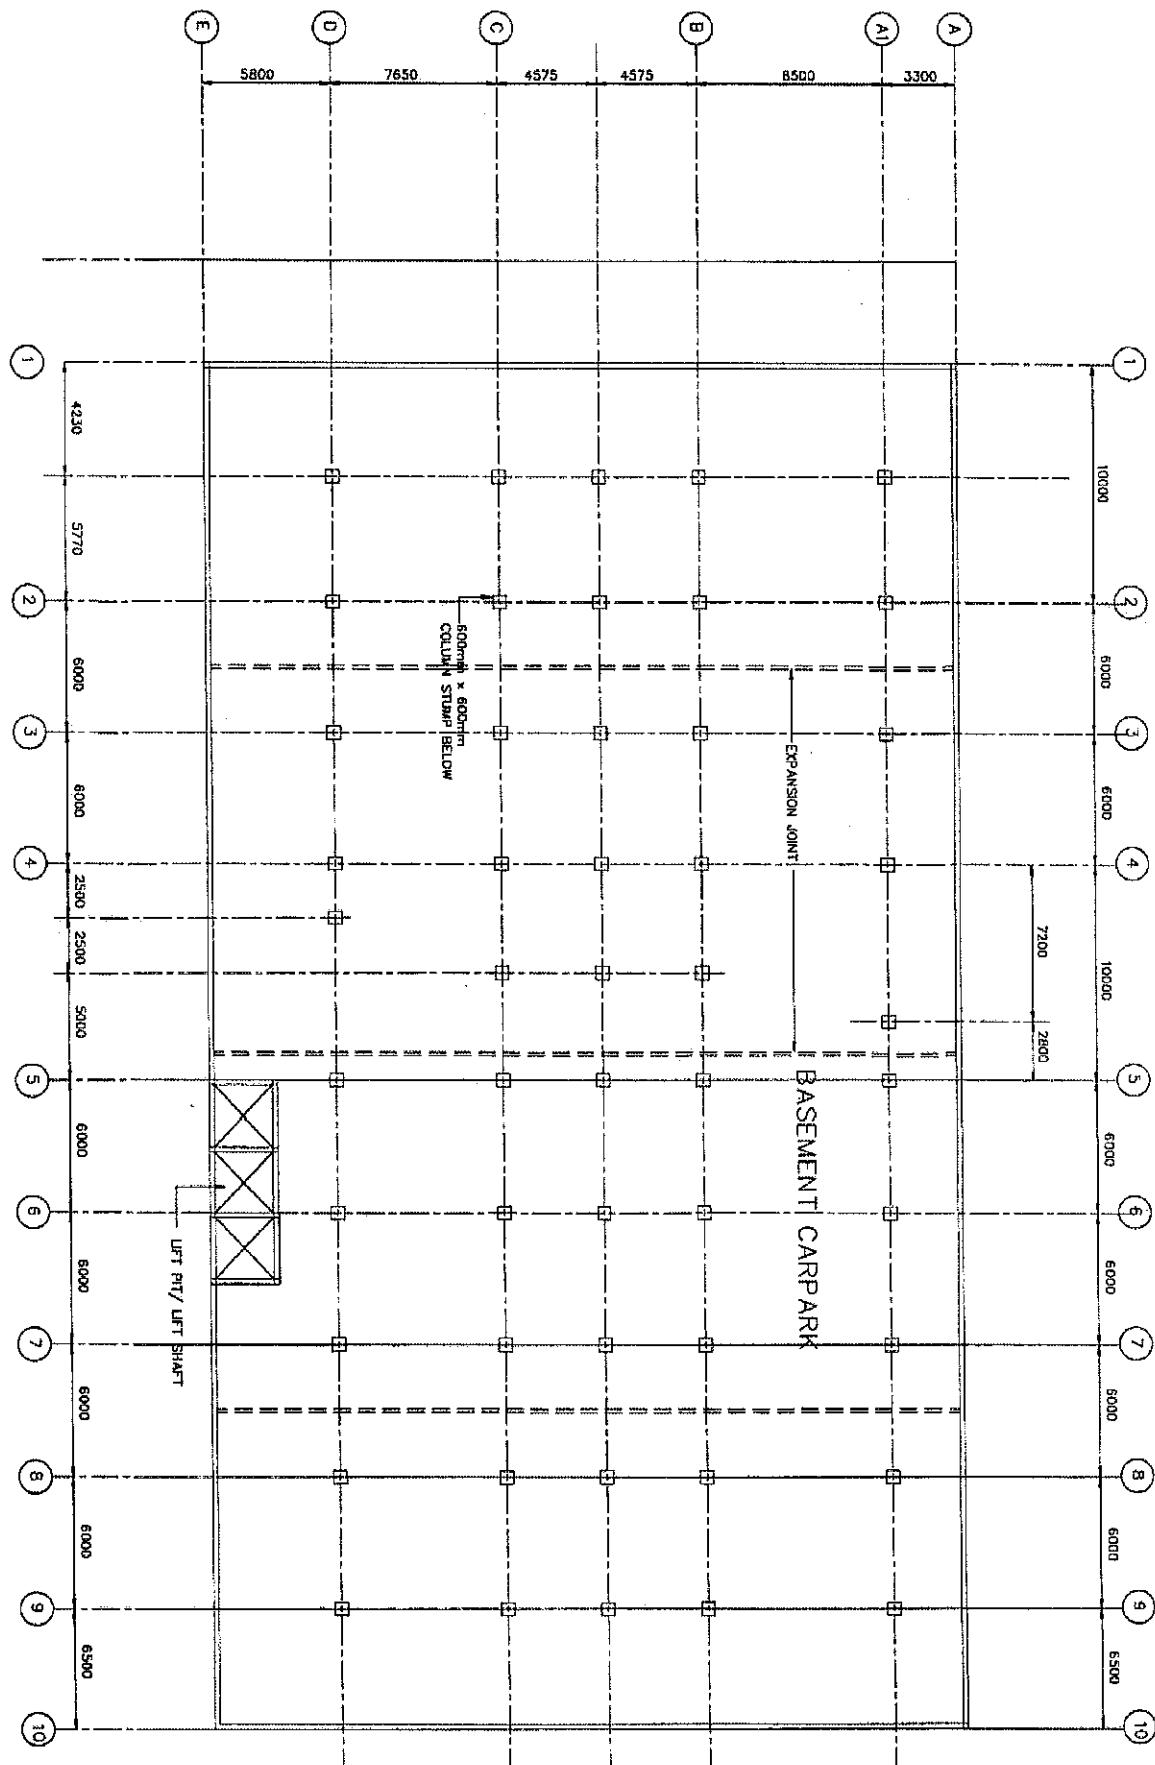

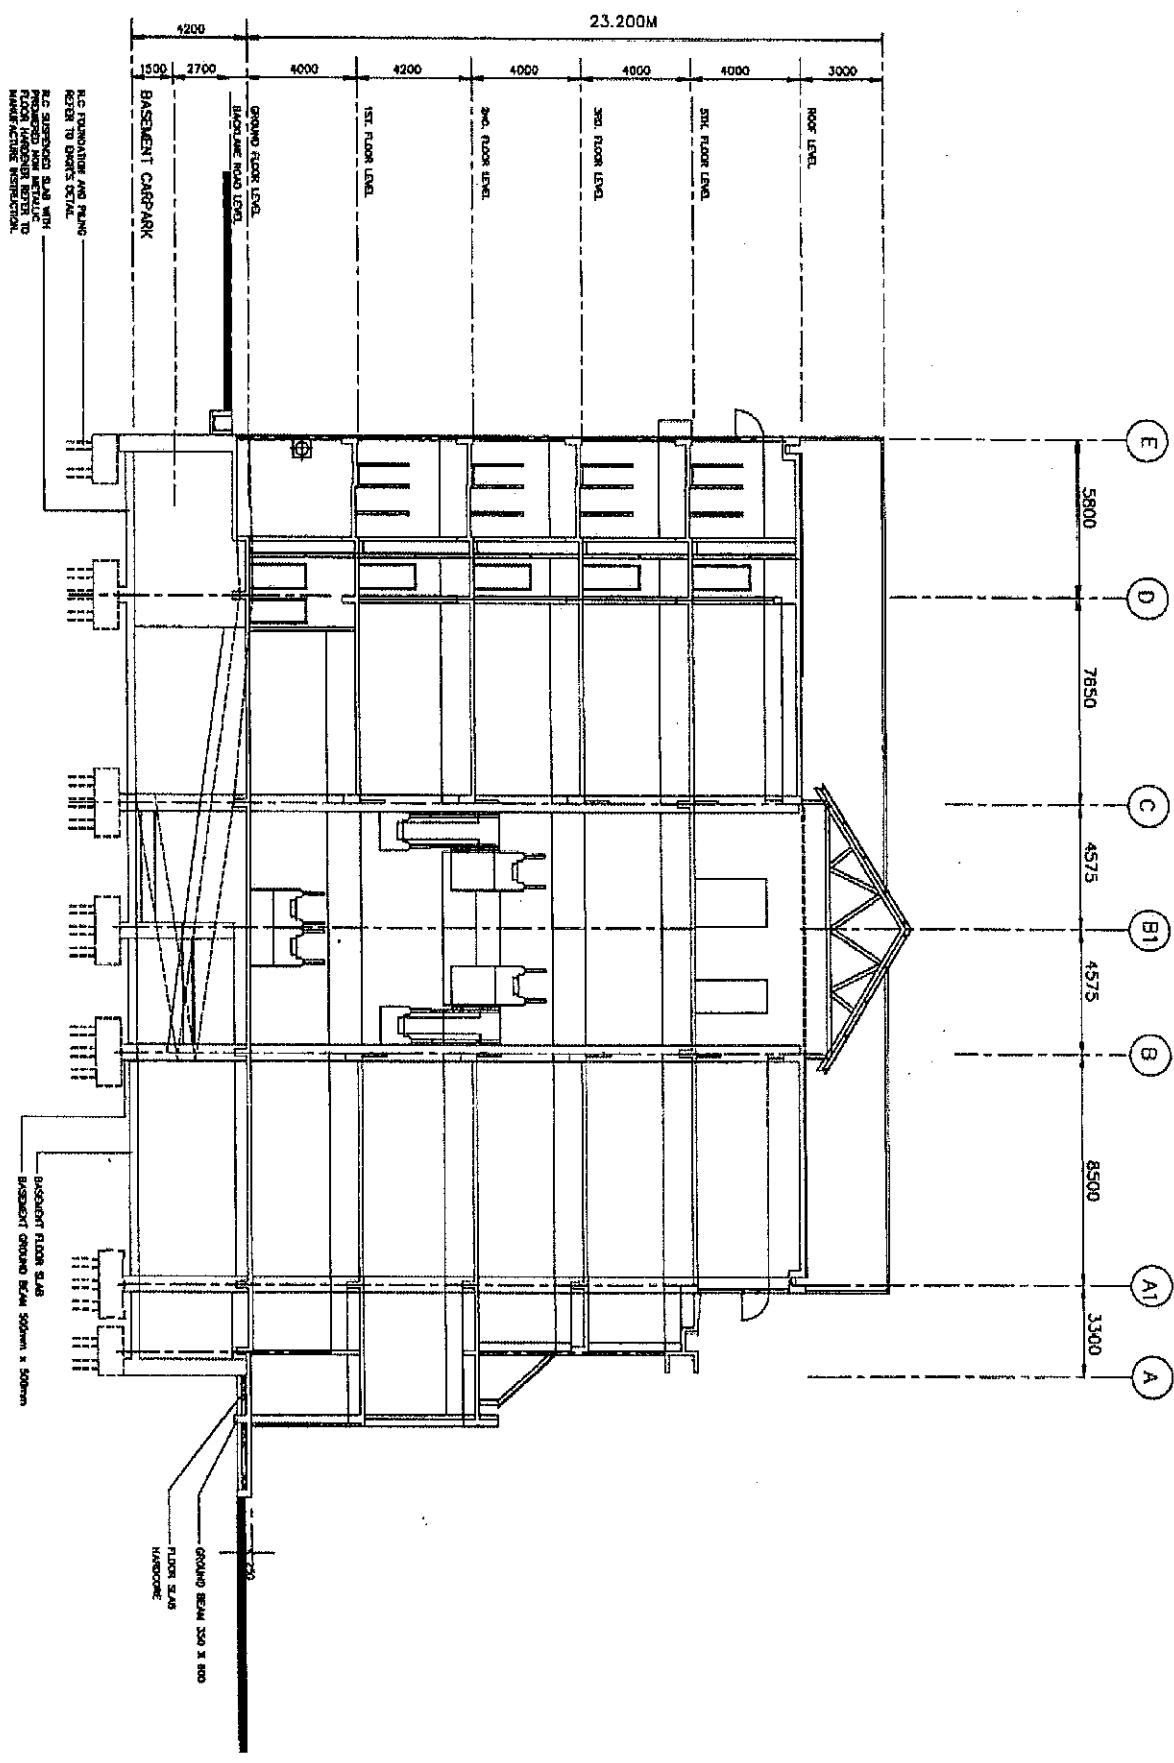

POLYCC
POLITEKNIK
DAN
KOLEJ
KOMUNITI

CADANGAN MEMBINA DAN
MENYIAPKAN BANGUNAN KUARTERS
5 TINGKAT BESERTA RUANG LETAK
KERETA BAWAH TANAH


PROJECT:

DRAWING TITLE:
BASEMENT SECTION DETAILS

SUBJECT:

BUILDING WORKS
MEASUREMENT 3


PREPARED BY : AZIE
SCALE : NTS
DATE : OGOS 2024
DRAWING NO.: DCQ30154/BASEMENT/02
COURSE CODE: DCQ30154

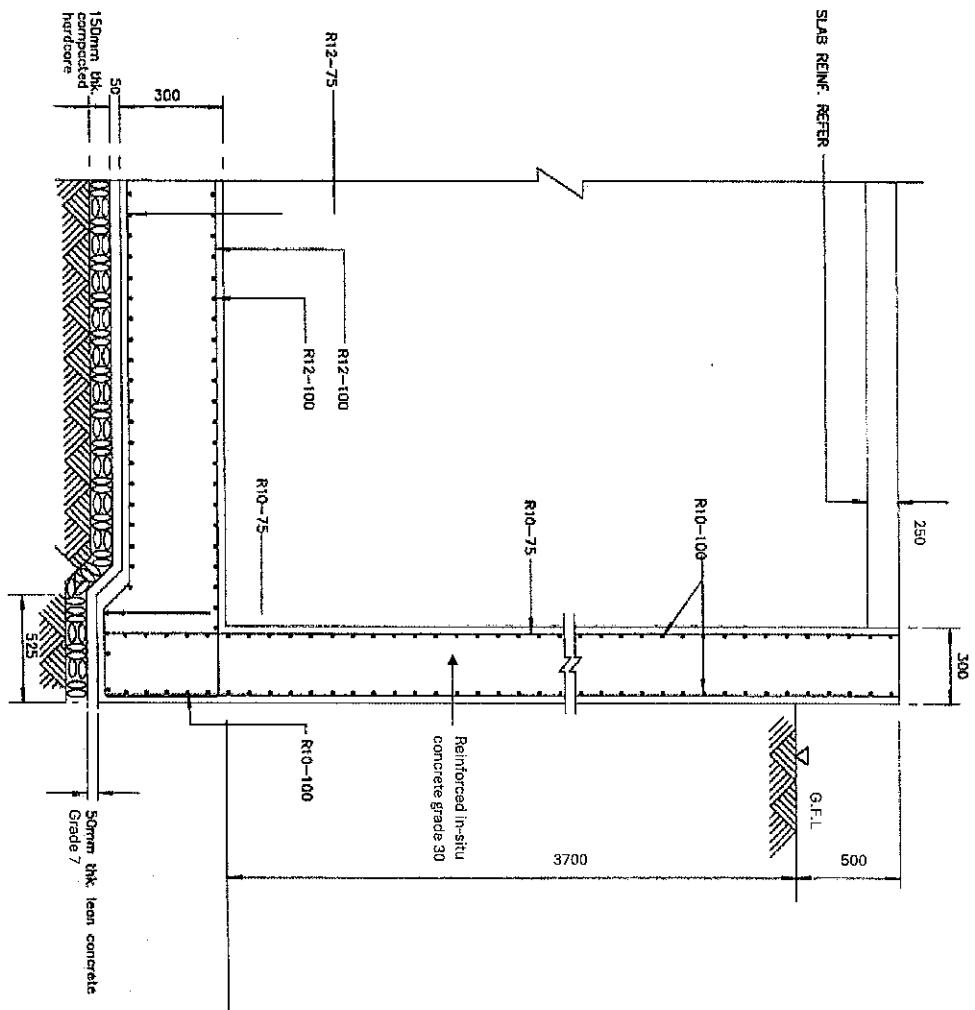

TYPICAL PLAN FOR
BASEMENT WALL

TYPICAL DETAIL OF EXPANSION JOINT
IN BASEMENT WALL/SLAB

TYPICAL DETAIL OF EXPANSION JOINT
TO THE EXTERIOR BASEMENT

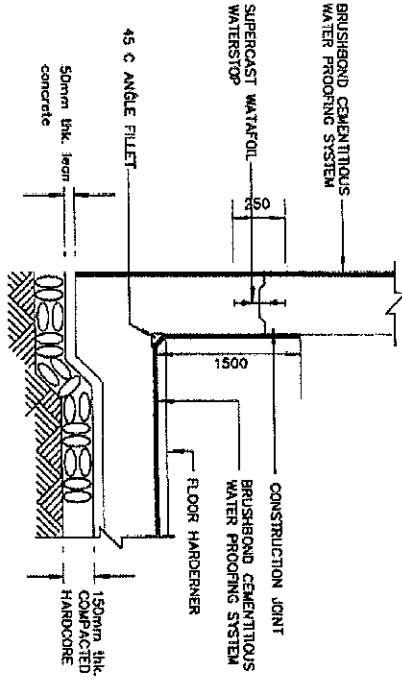

POLYCC
CADANGAN MEMBINA DAN
MENYIAPKAN BANGUNAN KUARTERS
5 TINGKAT BESERTA RUANG LETAK
KERETA BAWAH TANAH

PROJECT:
DRAWING TITLE:
BASEMENT SECTION DETAILS

SUBJECT:
BUILDING WORKS
MEASUREMENT 3

PREPARED BY : AZIE
SCALE : NTS
DATE : OGOS 2024
DRAWING NO.: DCQ30154/BASEMENT/03

COURSE CODE: DCQ30154