

**SULIT**



**KEMENTERIAN PENDIDIKAN TINGGI  
JABATAN PENDIDIKAN POLITEKNIK DAN KOLEJ KOMUNITI**

**BAHAGIAN PEPERIKSAAN DAN PENILAIAN  
JABATAN PENDIDIKAN POLITEKNIK DAN KOLEJ KOMUNITI  
KEMENTERIAN PENDIDIKAN TINGGI**

**JABATAN KEJURUTERAAN AWAM**

**PEPERIKSAAN AKHIR  
SESI II : 2022/2023**

**DCQ50244: BUILDING WORKS MEASUREMENT 5**

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**TARIKH : 07 JUN 2023  
MASA : 8.30 PG – 10.30 PG (2 JAM)**

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Kertas ini mengandungi **LAPAN (8)** halaman bercetak.

Bahagian A: Subjektif (2 soalan)

Bahagian B: Subjektif (4 soalan)

Dokumen sokongan yang disertakan : Kertas Dimensa / Kertas Billing / Lukisan

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**JANGAN BUKA KERTAS SOALANINI SEHINGGA DIARAHKAN**  
(CLO yang tertera hanya sebagai rujukan)

**SULIT**

**SECTION A: 50 MARKS*****BAHAGIAN A :50 MARKAH*****INSTRUCTION:**

This section consists of **TWO (2)** subjective questions. Answer **ALL** questions.

**ARAHAN:**

*Bahagian ini mengandungi DUA (2) soalan subjektif. Jawab SEMUA soalan.*

**Notes:**

1. Taking off refers to the rules in Standard Method of Measurement for Building Works Second Edition (SMM2).

*Pengiraan hendaklah merujuk kepada Kaedah Pengukuran Kuantiti Piawai Edisi Kedua (SMM2).*

2. Candidate is allowed to make any assumption if the information given in the drawing is inadequate.

*Pelajar boleh membuat andaian yang munasabah jika maklumat di dalam lukisan tidak memadai.*

3. Marks will be given for the knowledge of the subject and systematic setting of dimensions, adequacy and accuracy of description and dimensions.

*Markah akan diberikan berdasarkan pengetahuan tentang subjek dan dimensi yang sistematis, kecukupan dan ketepatan penerangan dan dimensi.*

**QUESTION 1*****SOALAN 1***

CLO1

- (a) Describe the method of designation for the sizes and components of steelwork members according to Standard Method of Measurement for Building Works Second Edition (SMM2).

*Huraikan kaedah penetapan untuk saiz dan komponen bagi kerja keluli mengikut Kaedah Pengukuran Kuantiti Piawai Edisi Kedua (SMM2).*

[5 marks]

[5 markah]

- CLO1 (b) Based on Drawing No. **DCQ50244/STEELWORK/AQ1/01**, prepare the quantities measurement for universal beams (I BEAM 2) and universal column (C2).

*Berdasarkan Lukisan No. DCQ50244/STEELWORK/AQ1/01, sediakan pengukuran kuantiti bagi rasuk universal (I BEAM 2) dan tiang universal (C2).*

[10 marks]

[10 markah]

- CLO1 (c) Based on Drawing No. **DCQ50244/STEELWORK/AQ1/02**, prepare the quantities measurement for structural steelwork for item column and top tier beam of water tank.

*Merujuk kepada lukisan No. DCQ50244/STEELWORK/AQ1/02, sediakan kuantiti untuk kerja struktur besi untuk item tiang dan rasuk utama bagi tangki air.*

[10 marks]

[10 markah]

## QUESTION 2

### SOALAN 2

- CLO1 (a) Referring to Standard Method of Measurement 2 (SMM 2), explain clause V.5.1 which refer to method of measurement of pipe works.

*Merujuk kepada Kaedah Pengukuran Kuantiti Piawai (SMM 2), terangkan klausa V.5.1 yang menerangkan kaedah pengukuran bagi kerja-kerja paip.*

[5 marks]

[5 markah]

- CLO1 (b) Referring to Drawing No. **DCQ50244/WATERREC/AQ2/01-02**, complete the Table 1 for preparation of Bill of Quantities based on the provisions in Standard Method of Measurement 2 (SMM2).

*Merujuk kepada lukisan No. **DCQ50244/WATERREC/AQ2/01-02**, lengkapkan Jadual 1 dalam penyediaan Senarai Kuantiti dengan merujuk kepada peruntukan di dalam Kaedah Pengukuran Kuantiti Piawai 2 (SMM2).*

Table 1  
Jadual 1

No/ Bil	Item/ Item	Unit/ Unit	Description /Keterangan Kerja
1	600mm HDPE / 600mm HDPE		
2	Hydrant / Pili bomba		
3	Sluice Valve/ Injap		
4	Granular bedding / Alas Granular		

[10 marks]

[10 markah]

- CLO1 (c) Based on Drawing No. **DCQ50244/WATERREC/AQ2/01-02**, calculate the quantities measurement for water reticulation works for 600mm diameter High Density Polyethylene (HDPE) pipe and hydrant.

*Merujuk kepada Lukisan No. **DCQ50244/WATERREC/AQ2/01-02**, kirakan pengukuran kuantiti bagi kerja sistem bekalan air untuk 600mm diameter paip jenis politena ketumpatan tinggi (HDPE) dan pili bomba.*

[10 marks]

[10 markah]

**SECTION B: 100 MARKS*****BAHAGIAN B :100 MARKAH*****INSTRUCTION:**

This section consists of **FOUR (4)** subjective questions. Answer **TWO (2)** questions only.

**ARAHAN:**

*Bahagian ini mengandungi EMPAT (4) soalan subjektif. Jawab DUA (2) soalan sahaja.*

**QUESTION 1*****SOALAN 1***

- CLO1 (a) Referring to Drawing No. **DCQ50244/LANDSCAPE/BQ1/01**, prepare the quantities measurement for planting Tristaniopsis Spp and Caesalpinia Ferrea.  
*Merujuk kepada Lukisan No. DCQ50244/LANDSCAPE/BQ1/01, sediakan pengukuran kuantiti bagi kerja-kerja penanaman pokok Tristaniopsis Spp dan Caesalpinia Ferrea.*
- [8 marks]  
[8 markah]
- CLO1 (b) Referring to Drawing No. **DCQ50244/LANDSCAPE/BQ1/02**, conclude a bill of quantities complete with quantities measurement for mulching and spot turfing.  
*Merujuk kepada Lukisan No. DCQ50244/LANDSCAPE/BQ1/02, rumuskan satu senarai kuantiti lengkap dengan pengukuran kuantiti bagi kerja-kerja 'mulching' dan rumput tompok.*
- [17 marks]  
[17 markah]

**QUESTION 2****SOALAN 2**

- CLO1 (a) Referring to Drawing No. **DCQ50244/ DRAINAGE/BQ2/01**, measure the quantities of excavation for 350mm diameter precast concrete drain (S1 to S4).  
*Merujuk kepada lukisan No. DCQ50244/DRAINAGE/BQ2/01, ukur kuantiti pengorekan bagi 350mm ukur lilit longkang konkrit pratuang (S1 hingga S4).*
- [8 marks]  
[8 markah]
- CLO1 (b) Based on Drawing No. **DCQ50244/DRAINAGE/BQ2/01**, conclude a bill of quantities complete with quantities measurement for 350mm diameter precast concrete drain and weepholes (S1-S4).  
*Merujuk kepada lukisan No. DCQ50244/DRAINAGE/BQ2/01, rumuskan senarai kuantiti lengkap dengan pengukuran kuantiti bagi 350mm ukur lilit longkang konkrit pra tuang dan lubang sesalir (S1 hingga S4).*
- [17 marks]  
[17 markah]

**QUESTION 3****SOALAN 3**

- CLO1 (a) Based on Drawing No. **DCQ50244/SEWERAGE/BQ3/01**, prepare the quantities measurement for manhole and lean concrete to receive manhole.  
*Berdasarkan lukisan bernombor DCQ50244/SEWERAGE/BQ3/01, sediakan pengukuran kuantiti bagi pengorekan dan konkrit alas dalam lurang.*

[8 marks]

[8 markah]

- CLO1 (b) Based on Drawing No. **DCQ50244/SEWERAGE/BQ3/02**, conclude a bill of quantities complete with quantities measurement for sewerage works for MH1, MH2, and MH3 (Excavation and concrete base only).  
*Berdasarkan kepada Lukisan Bernombor DCQ50244/SEWERAGE/BQ3/02, rumuskan satu senarai kuantiti lengkap dengan pengukuran kuantiti bagi kerja-kerja pembentungan untuk MH1, MH2, dan MH3 (Kerja pengorekan dan konkrit asas sahaja).*

[17 marks]

[17 markah]

**QUESTION 4****SOALAN 4**

- CLO1 (a) Based on Drawing No. **DCQ50244/FENCING&DEMOLISH/BQ4/01-02**, calculate the quantities measurement for barb wire and PVC coated chain link fencing.

*Merujuk kepada lukisan No. DCQ50244/FENCING&DEMOLISH/BQ4/01-02, ukur kuantiti ‘barb wire’ dan pagar rantai bersalut PVC.*

[8 marks]

[8 markah]

- CLO1 (b) Based on Drawing No. **DCQ50244/FENCING&DEMOLISH/BQ4/01-02**, conclude a bill of quantities complete with quantities measurement for demolition and renovation works.

*Merujuk kepada lukisan No. DCQ50244/FENCING&DEMOLISH/BQ4/01-02, rumuskan senarai kuantiti lengkap dengan pengukuran kuantiti bagi kerja-kerja perobohan dan pengubahsuaian.*

[17 marks]

[17 markah]

**SOALAN TAMAT**

**SECTION A: 50 MARKS*****BAHAGIAN A :50 MARKAH*****INSTRUCTION:**

This section consists of **TWO (2)** subjective questions. Answer **ALL** questions.

**ARAHAN:**

*Bahagian ini mengandungi DUA (2) soalan subjektif. Jawab SEMUA soalan.*

**Notes:**

1. Taking off refers to the rules in Standard Method of Measurement for Building Works Second Edition (SMM2).

*Pengiraan hendaklah merujuk kepada Kaedah Pengukuran Kuantiti Piawai Edisi Kedua (SMM2).*

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**QUESTION 1*****SOALAN 1***

CLO1

- (a) Describe the method of designation for the sizes and components of steelwork members according to Standard Method of Measurement for Building Works Second Edition (SMM2).

*Huraikan kaedah penetapan untuk saiz dan komponen bagi kerja keluli mengikut Kaedah Pengukuran Kuantiti Piawai Edisi Kedua (SMM2).*

[5 marks]

[5 markah]

- CLO1 (b) Referring to Drawing No. **DCQ50244/WATERREC/AQ2/01-02**, complete the Table 1 for preparation of Bill of Quantities based on the provisions in Standard Method of Measurement 2 (SMM2).

*Merujuk kepada lukisan No. DCQ50244/WATERREC/AQ2/01-02, lengkapkan Jadual 1 dalam penyediaan Senarai Kuantiti dengan merujuk kepada peruntukan di dalam Kaedah Pengukuran Kuantiti Piawai 2 (SMM2).*

Table 1  
Jadual 1

No/ Bil	Item/ Item	Unit/ Unit	Description /Keterangan Kerja
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4	Granular bedding / Alas Granular		

[10 marks]

[10 markah]

- CLO1 (c) Based on Drawing No. **DCQ50244/WATERREC/AQ2/01-02**, calculate the quantities measurement for water reticulation works for 600mm diameter High Density Polyethylene (HDPE) pipe and hydrant.

*Merujuk kepada Lukisan No. DCQ50244/WATERREC/AQ2/01-02, kirakan pengukuran kuantiti bagi kerja sistem bekalan air untuk 600mm diameter paip jenis politena ketumpatan tinggi (HDPE) dan pili bomba.*

[10 marks]

[10 markah]

**QUESTION 2****SOALAN 2**

- CLO1 (a) Referring to Drawing No. **DCQ50244/ DRAINAGE/BQ2/01**, measure the quantities of excavation for 350mm diameter precast concrete drain (S1 to S4).  
*Merujuk kepada lukisan No. DCQ50244/DRAINAGE/BQ2/01, ukurkan kuantiti pengorekan bagi 350mm ukur lilit longkang konkrit pratuang (S1 hingga S4).*
- [8 marks]  
[8 markah]
- CLO1 (b) Based on Drawing No. **DCQ50244/DRAINAGE/BQ2/01**, conclude a bill of quantities complete with quantities measurement for 350mm diameter precast concrete drain and weepholes (S1-S4).  
*Merujuk kepada lukisan No. DCQ50244/DRAINAGE/BQ2/01, rumuskan senarai kuantiti lengkap dengan pengukuran kuantiti bagi 350mm ukur lilit longkang konkrit pra tuang dan lubang sesalir (S1 hingga S4).*
- [17 marks]  
[17 markah]

**QUESTION 4****SOALAN 4**

- CLO1 (a) Based on Drawing No. DCQ50244/FENCING&DEMOLISH/BQ4/01-02, calculate the quantities measurement for barb wire and PVC coated chain link fencing.

*Merujuk kepada lukisan No. DCQ50244/FENCING&DEMOLISH/BQ4/01-02, ukur kuantiti ‘barb wire’ dan pagar rantai bersalut PVC.*

[8 marks]

[8 markah]

- CLO1 (b) Based on Drawing No. DCQ50244/FENCING&DEMOLISH/BQ4/01-02, conclude a bill of quantities complete with quantities measurement for demolition and renovation works.


*Merujuk kepada lukisan No. DCQ50244/FENCING&DEMOLISH/BQ4/01-02, rumuskan senarai kuantiti lengkap dengan pengukuran kuantiti bagi kerja-kerja perobohan dan pengubahsuaian.*

[17 marks]


[17 markah]

**SOALAN TAMAT**


**NOTES:**  
**YOU CAN MAKE**  
**ALL NECESSARY**  
**ASSUMPTIONS**  
**WHERE APPLICABLE**

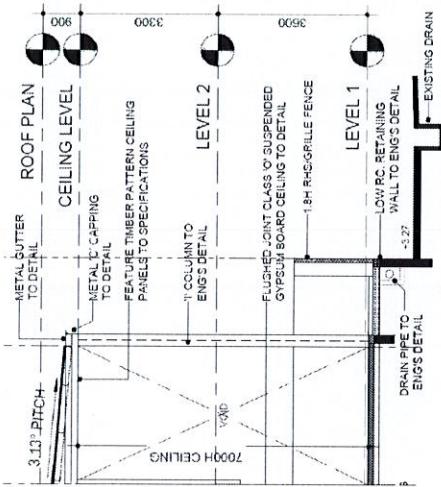

FIRST FLOOR KEY PLAN

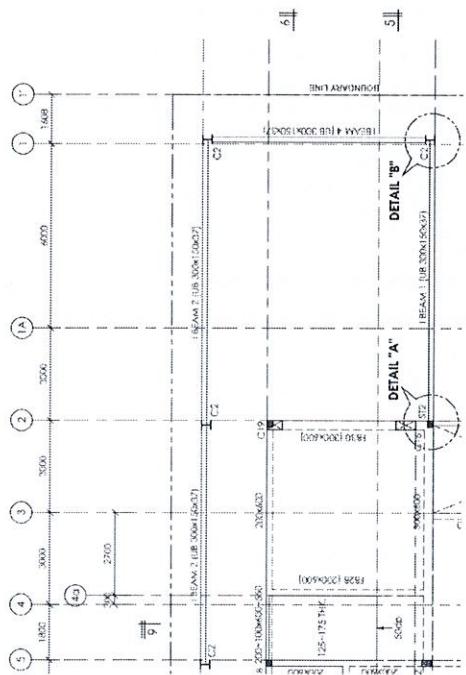

9000

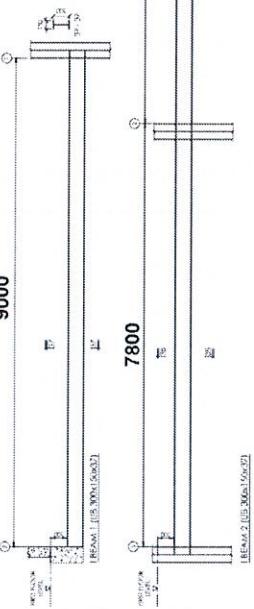


SECTION (LEFT ELEVATION)

**PROJECT TITLE:**

**DRAWING TITLE:**  
**KEY PLAN/COLUMN**  
**& BEAM DETAILS**


**COLUMN REINFORCEMENT SCHEDULE**

COLUMN MARK	FLOOR	REINFORCEMENT		
		C1	C2	C3
MAIN SP. C1	1ST FLOOR	X	X	X
MAIN SP. C2	2ND FLOOR	X	X	X
MAIN SP. C3	3RD FLOOR	X	X	X
MAIN SP. C4	ROOF	X	X	X
COL. SIZE		4125x1200x350x350	4125x1200x350x350	4125x1200x350x350
MAIN BARS		300x300x235x235	300x300x235x235	300x300x235x235
COL. SIZE		350x250	350x250	350x250

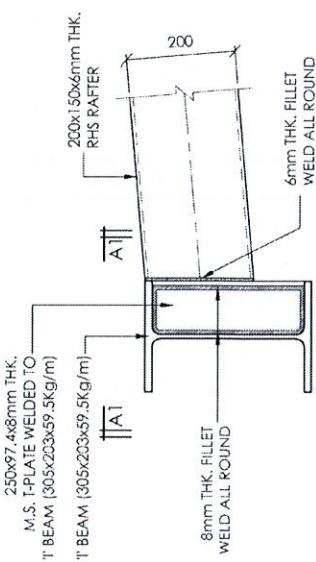



ENLARGEMENT OF DETAILS "A"

**DRAWING NO:**  
**DCQ50244/STEELWORK/AQ1/01**

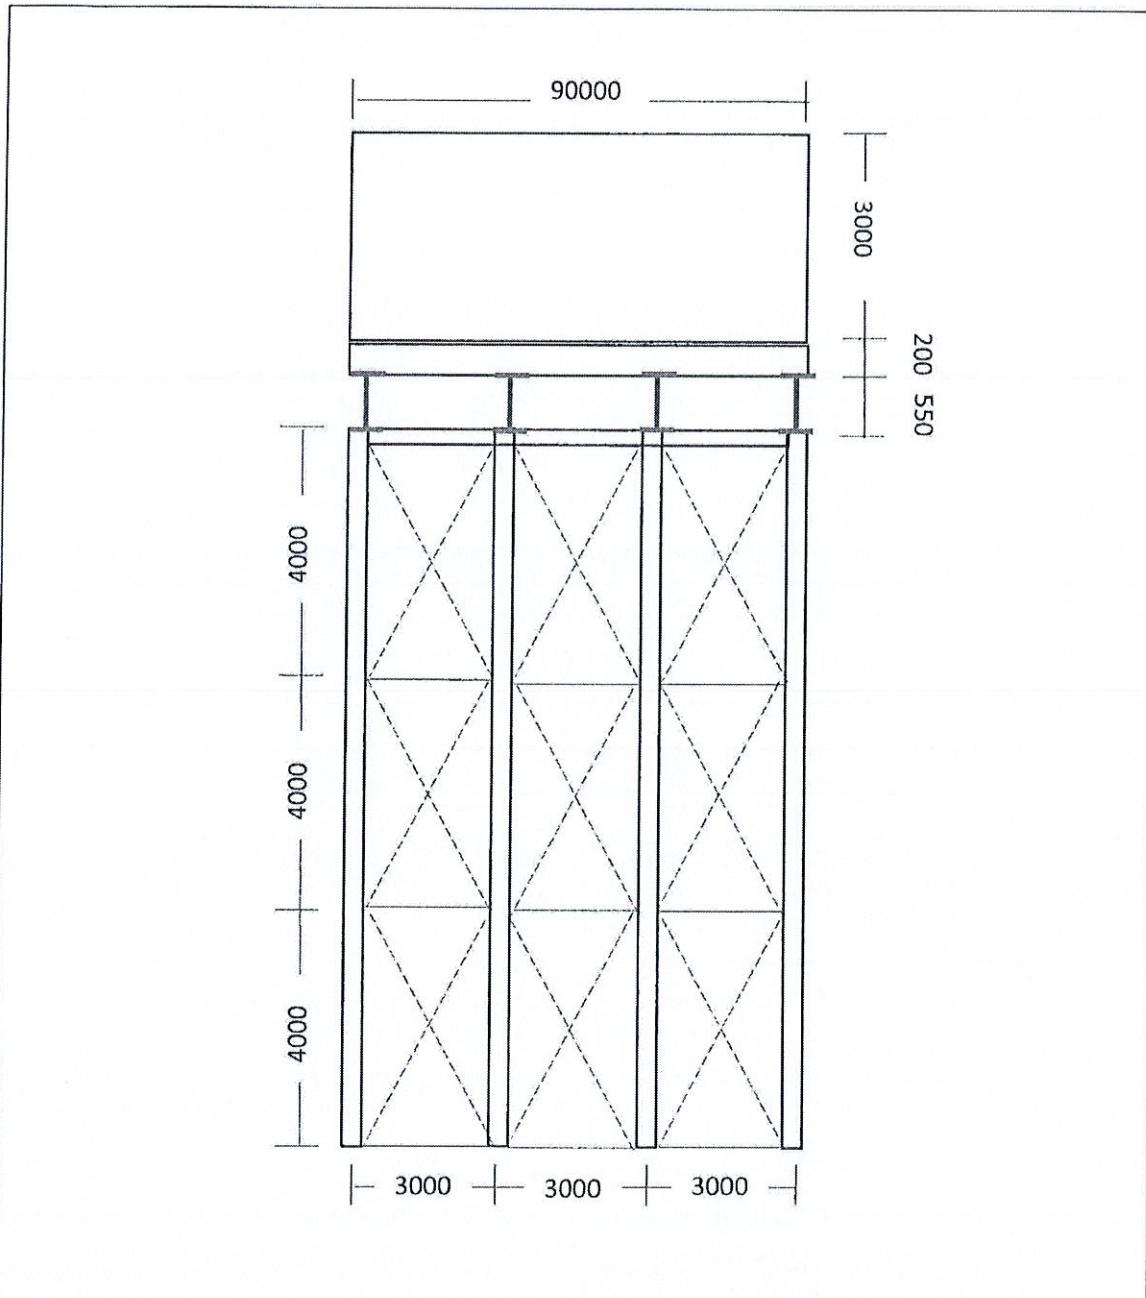

PROJECT: CADANGAN MEMBINA & MENYIAPKAN TANGKI AIR DI KAWASAN PERUMAHAN DI LOT 53 DAERAH MUALLIM, PERAK.	NOTE: 1. Horizontal bracing 80 x 80 x 8kg/m 2. Bracing 80 x 80 x 8kg/m 3. Column 205 x 205 x 46kg/m 4. Top tier beam 254 x 102 x 28kg/m 5. Bottom tier beam 475 x 152 x 74 kg/m
<b>POLITEKNIK</b> MALAYSIA	DRAWING TITLE: ELEVATION FOR ALL SIDE OF WATER TANK
	SCALE: NOT TO SCALE
	DRAWING NO: DCQ50244/STEELWORK/AQ1/02


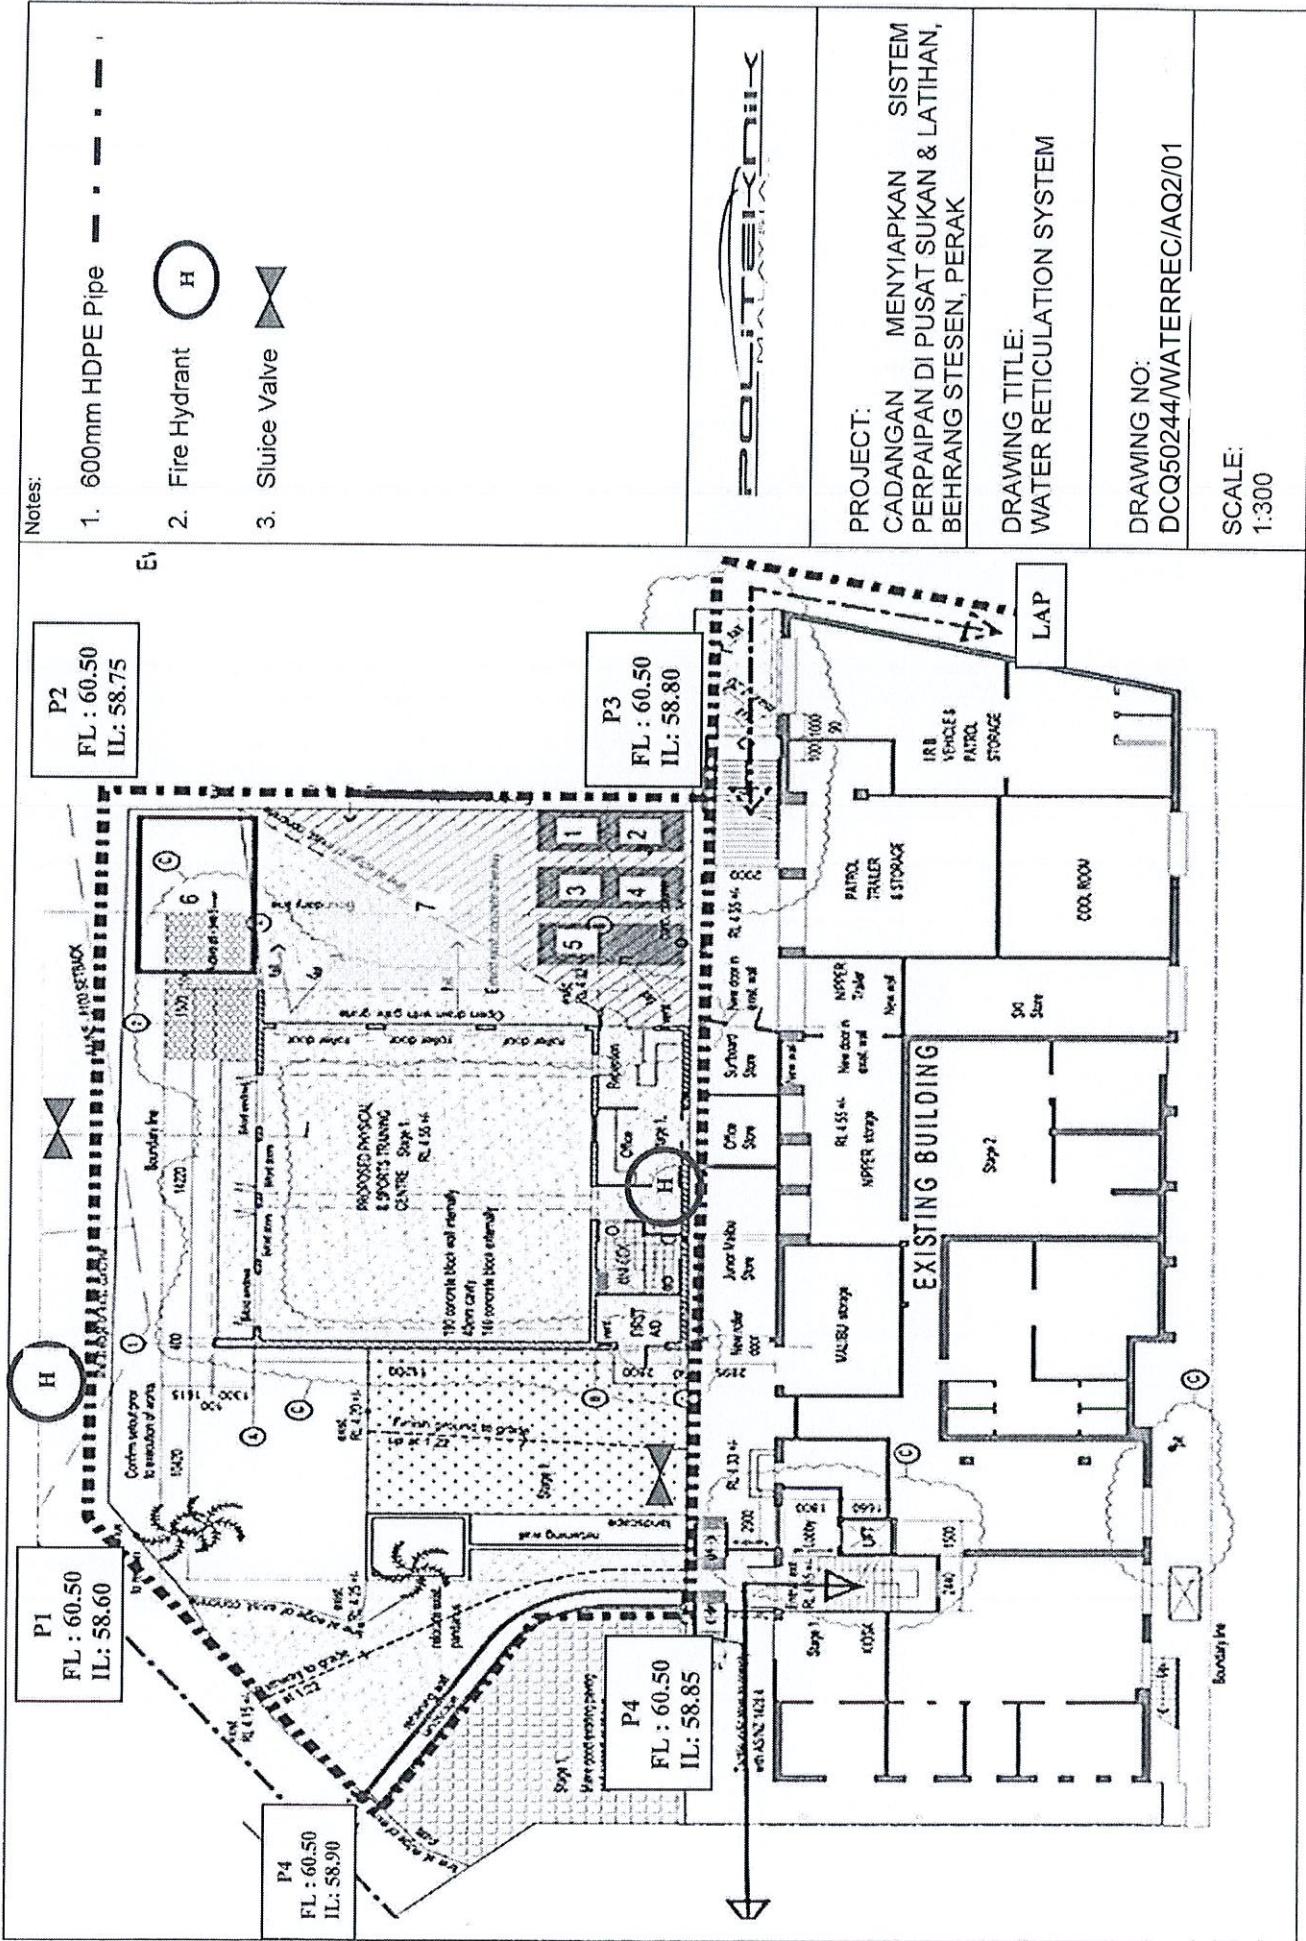


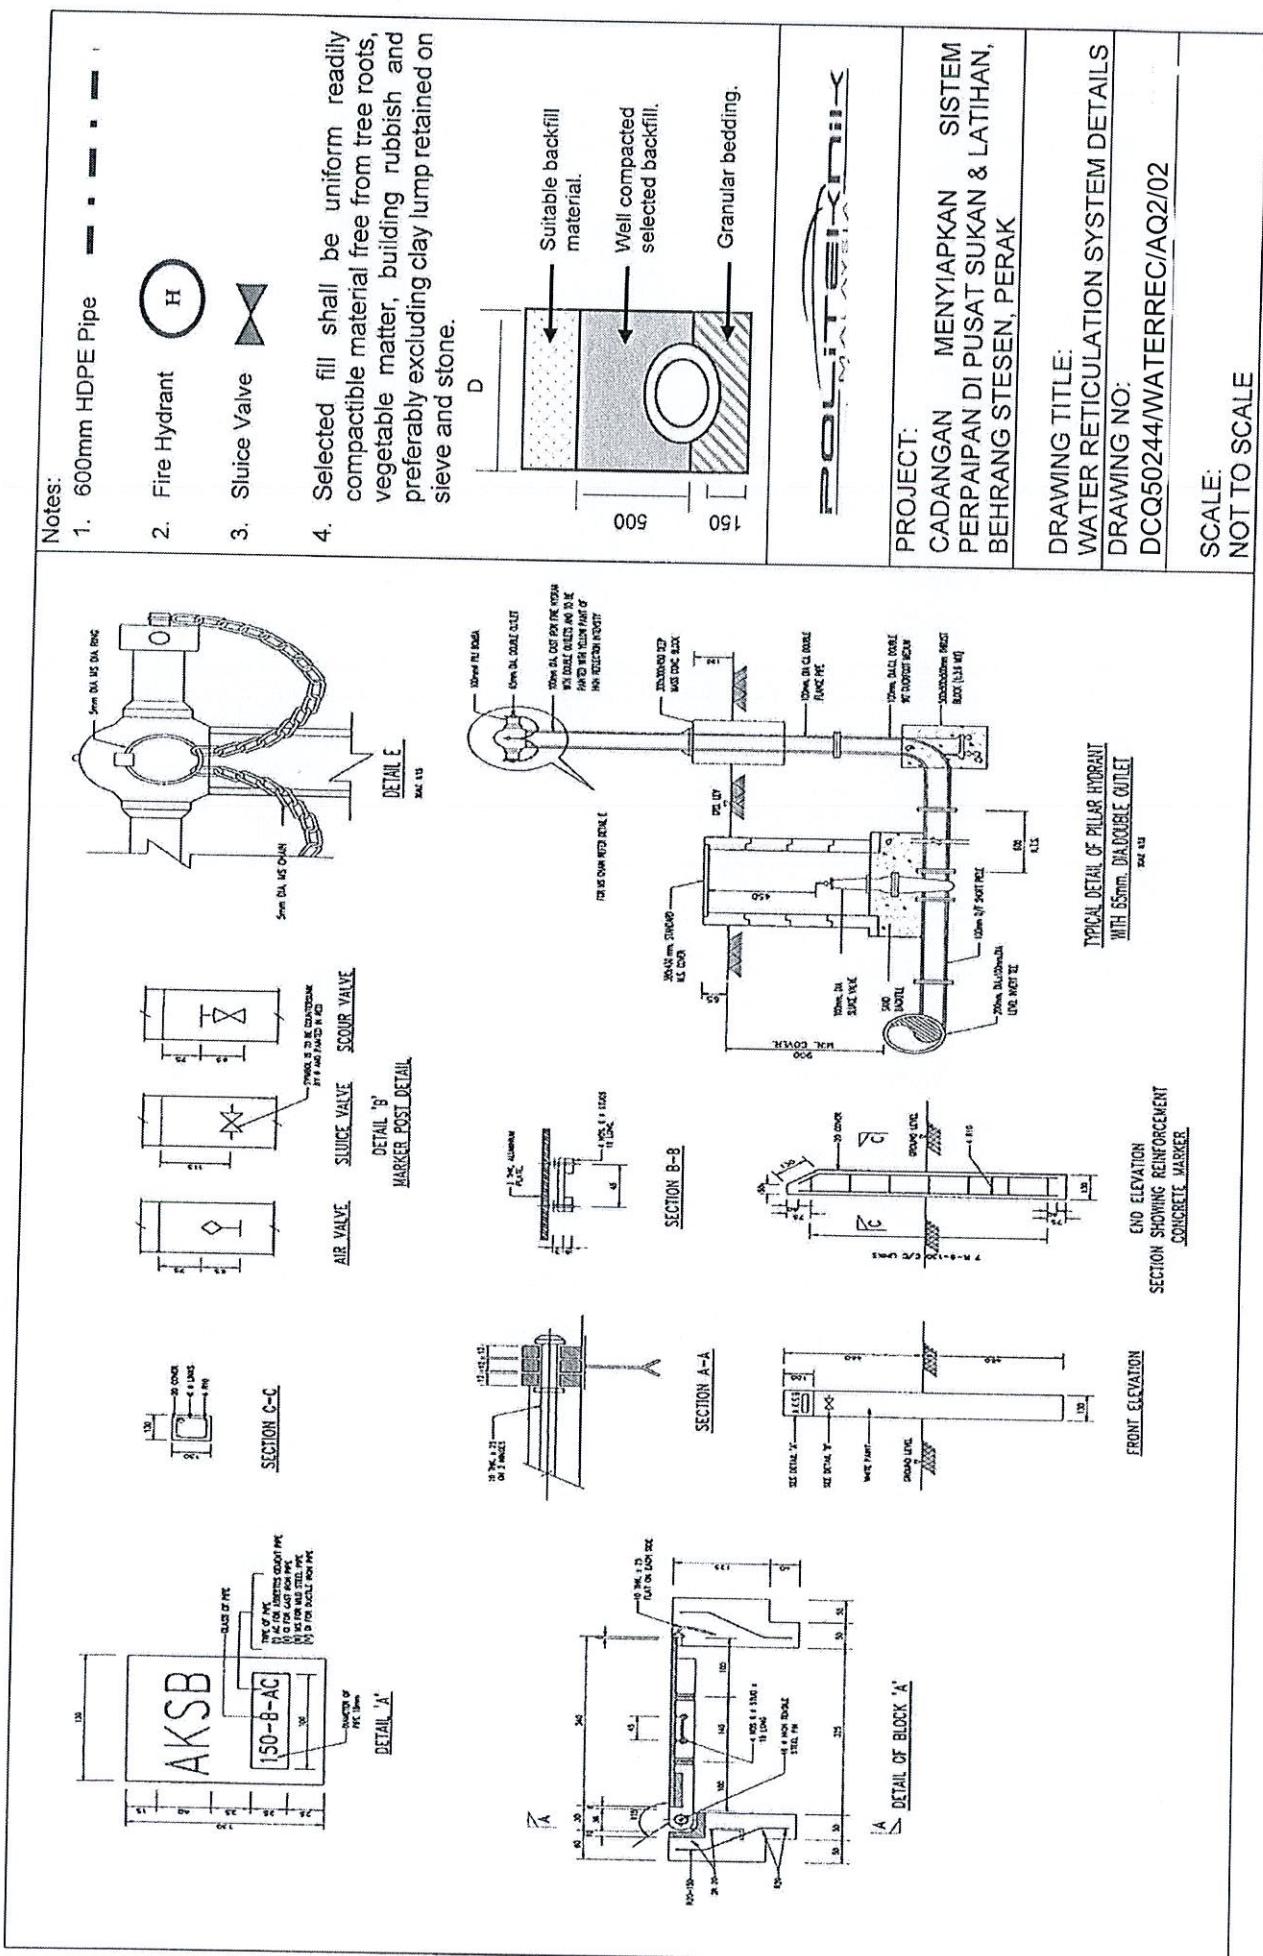

**NOTES:**  
**YOU CAN MAKE**  
**ALL NECESSARY**  
**ASSUMPTIONS**  
**WHERE APPLICABLE**

**PROJECT TITLE:**

**DRAWING NO:**  
**DCCQ50244/LANDSCAPE/BQ1/01**

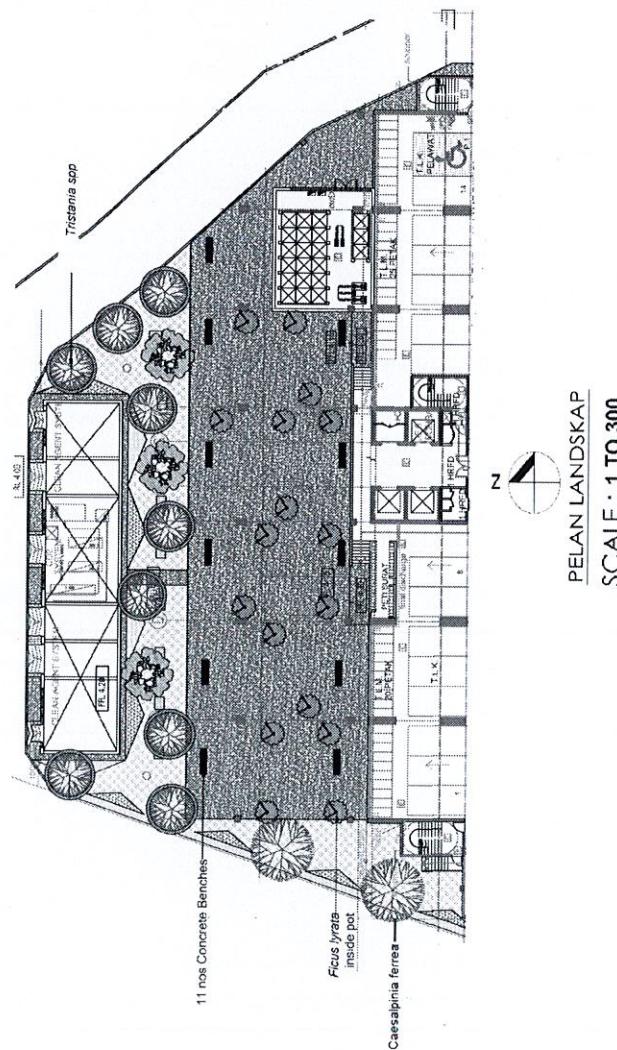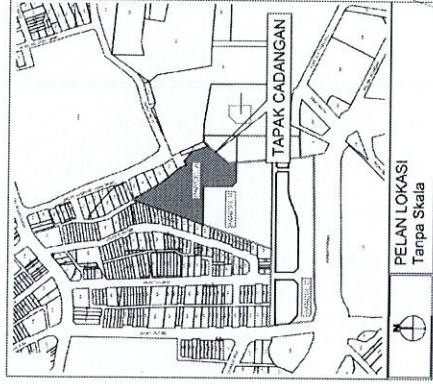

**PETUNJUK**

ITEM	SIMBOL	NAMA BOTANI	NAMA BIASA	KETINGGIAN MIN. DIA POKOK HT (MM)	BTG. (MM)
1.	(circle with dot)	Rivier Tristonia	Tristonia, Pedawan	2.5	50
2.	(circle with dot)	Leopard Trees		2.5	50
3.	(circle with dot)	Fiddle-leaf fig		2.5	50
4.	(circle with dot)	Jacaranda obtusifolia		2.5	50

- B. PENANAMAN POKOK (TREE PLANTING):**
1. Merupakan penanaman pokok atau mentakan tanah kepada tanah yang ditehendaki.
  2. Penggalian lubang bagi penanaman pokok (3 X 3) adalah termasuk menggunakan lubang tanan. Penggalian lubang mestilah dilakukan dengan menggunakan dronik mesial digali dengan tanah 'top soil' yang dibersihkan dengan compost dan 'organic fertilizer' dalam nisbah 1:1:1.
  3. Tanah yang diolah mesial digali dengan tanah 'top soil' yang dibersihkan dengan compost 10 darma tanah.
  4. Penggalian lubang sepatutnya berukur 100x100x100 mm.
  5. Kesanutan pokok-pokok yang dilakukan selepas penanaman pokok pada tanah (minimally) dengan ubat lili 50ml.
  6. Kayu pancing dan taring dawai ini masih lagi dicirikan kepada pokok pada ketinggian 5m dimana perlu sahaja kayu pancing untuk pokok taraik 25mmx25mmx2.75mm serta tall penghalat cislau dengan tulu getah 5jajhnya dan kesemua bongkeling pili bomba dan tan dan kemudahan awam.
  7. Kesemua pokok-pokok mesial di dalam di atas kaki lima (pavement) iaitu di antara berbilang jalan (road curb) dan longkang (round drain).
  8. Kesemua pokok-pokok mesial di dalam di atas jalan ia atau batu jalan yang dipermuka.
  9. Pokok-pokok yang ditanam di atas jalan ia atau batu jalan yang dipermuka perlu dibina kerikil berentuk kubuk kota sempat segi (1m X 1m).
  10. Pokok-pokok yang ditanam di atas jalan ia atau batu jalan yang dipermuka perlu dipasang dengan tanah 100mm di kaki pokok (mis. grating minima sekiranya kurang) salas campas 25mm lebar x 25mm tebal x 50mm jarak.


**D. LAPISAN RUMPUT (TURFING):**

1. 'Turfing' sebagaimana tertulis membuat dari 'cow grass' dan diharapkan tidak lebih dari 12X12' di antaranya dan mestilah disesuaikan sehingga rumput tumbuh. Turf mendandung halang minima akan dibuang manakala mina-mana taliang atau minesa yang mula tumbuh akan dicabut atau dikerekkan sebarang bayaran kerajaan majikan tersebut.

**LANDSCAPE LAYOUT**  
**& DETAILS**

NOTES:

YOU CAN MAKE  
ALL NECESSARY  
ASSUMPTIONS  
WHERE APPLICABLE

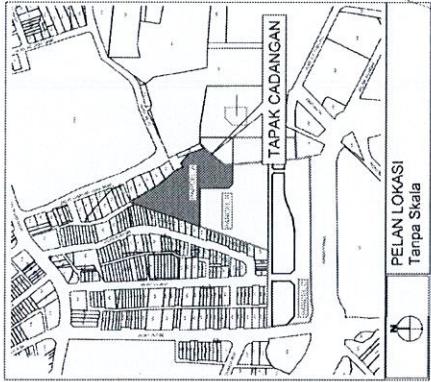


B. PENANAMAN POKOK (TREE PLANTING)

1. Merapikan perawaman tanah kepada tanah yang luang bagi penanaman pokok ('3' X '1') adalah termasuk.
2. Pengalih ruang tanah 'Regrade' usang 5 meter ditukarkan dengan tanah ('hard sugar' atau tanah basa HQ) iaitu menggunakan 'hard sugar' dan organik fertiliizer dalam misiak 1:1:1.
3. Tanah yang dikenali memiliki ligih dengan tanah "top soil" yang dipertukarkan dengan 'compost' dan 'organic fertilizer' dalam misiak 1:1:1.
4. Penambahbaikan bahan seperti 'rock phosphate' dan lain-lain lagi.
5. Kelembaban bahan juga seperti 'rock phosphate' masih mempunyai kelingkaran 2 meter dan aras tanah (minimum) bahan 'hard sugar' atau tanah basa HQ.
6. Kayu panjang dan jaring dewa ini mestilah diperlukan kepada pokok pada ketinggian 5 cm dari per sahaja. Kayu pasang untuk pokok utama iaian 25mmX30mmX2.70m serta tali berjirik disatut dengan tub gelati.
7. Kelembaban tanah yang dibutuhkan adalah mesilah pada pokok 5 jariannya dan kesemua longking, pilih bermula datamakan kemudahan.
8. Kelembaban pokok-pokok mestilah dijenam di atas tali lama (governement) iaitu di ambari berbebuhan jalan (road cut) dan lombong (read drain).
9. Pokok-pokok yang dijanam di atas bilau atau bukit yang diciptakan.
10. Pokok-pokok yang dijanam di atas bilau yang berbentuk kotak sempit segi (1m X 1m).
11. Pokok-pokok yang dijanam di atas bilau yang berbentuk kerucut kereka penilaian dengan m s grating 1mx1m di titik pokok. (m s grating penilaian sekejut-kurangnya saiz daripada 25mm lebar 12.5mm lebal X 50mm jarak).

D. LAPISAN RUMPUT TURFING

1. Turfing sebagai manfaat melihat dein 'cov grass' dan dilamparkan pada lebar dan '2'X'2' di antaranya dan mestilah dilengkapi sehingga rumpai turut mengganding diantara atau minces akan dibuang terhadap manfaat laisang atau minosa yang mudah tumbuh akan dicabut atau dikenaikan seberang bayangan kepada menjalin tersbut.

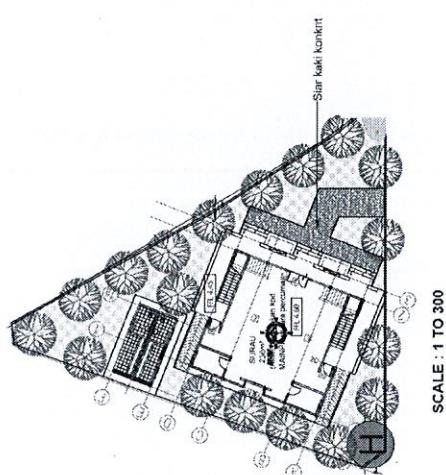

SCALE : 1 TO 300

PETUNJUK

i) POKOK

ITEM	SIMBOL	NAMA BOTANI	NAMA BIASA	KETINGGIAN POKOK (MM)	MIN. DIA. BTG. (MM)
1		Caesalpinia ferrea	Leopard Trees	2.5	50

PROJECT TITLE:

DRAWING TITLE:  
LANDSCAPE LAYOUT  
& DETAILS

iii) RUMPUT


ITEM	SIMBOL	NAMA BOTANI	NAMA BIASA
1.		Axonopus compressus	Cow grass

DRAWING NO.:  
DCQ50244/LANDSCAPE/BQ1/02




<p>Notes:</p> <table border="1"> <thead> <tr> <th>SUMP</th><th>REDUCE LEVEL (RL)</th><th>INVERT LEVEL (IL)</th></tr> </thead> <tbody> <tr><td>S1</td><td>64.00</td><td>63.47</td></tr> <tr><td>S2</td><td>64.00</td><td>63.44</td></tr> <tr><td>S3</td><td>64.00</td><td>63.41</td></tr> <tr><td>S4</td><td>64.00</td><td>63.40</td></tr> <tr><td>S5</td><td>64.00</td><td>63.39</td></tr> <tr><td>S6</td><td>64.00</td><td>63.37</td></tr> <tr><td>S7</td><td>64.00</td><td>63.36</td></tr> <tr><td>S8</td><td>64.00</td><td>63.35</td></tr> </tbody> </table>	SUMP	REDUCE LEVEL (RL)	INVERT LEVEL (IL)	S1	64.00	63.47	S2	64.00	63.44	S3	64.00	63.41	S4	64.00	63.40	S5	64.00	63.39	S6	64.00	63.37	S7	64.00	63.36	S8	64.00	63.35	<p>PROJECT: CADANGAN LONGKANG UTAMA DI PEJABAT MAJLIS BANDARAYA SELANGOR.</p>	<p>DRAWING TITLE: SURFACE WATER DRAINAGE</p>		<p>DRAWING NO: DCQ50244/DRAINAGE/BQ2/01</p>
SUMP	REDUCE LEVEL (RL)	INVERT LEVEL (IL)																													
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S8	64.00	63.35																													
		<p>230 THK. F/RK. WITH 20 THK. CEMENT RENDERING TO EXPOSED SURFACES</p> <p>230 X 230 AGGREGATE PACKING WITH GEOTEXTILE CLASS B WRAPPING A/L ROUND</p> <p>75mm PVC WEEP HOLES AT 3m C/C</p> <p>350 SGW H/R SECTION 50mm Thick 300mm thick grade 20 concrete</p>	<p>SUMPS</p>	<p>SCALE: 1:200</p>																											

NOTES:

YOU CAN MAKE ALL  
NECESSARY AND  
REASONABLE  
ASSUMPTIONS  
WHERE APPLICABLE

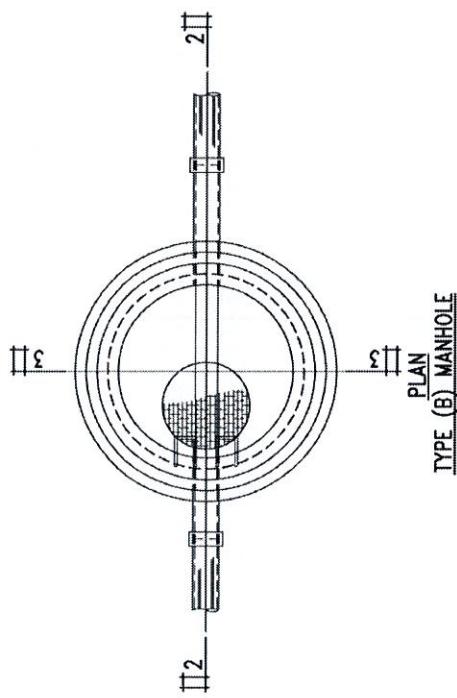

MANHOLE DETAILS MH1 :	
Ground Level	4300mm
Manhole Invert Level	2175mm

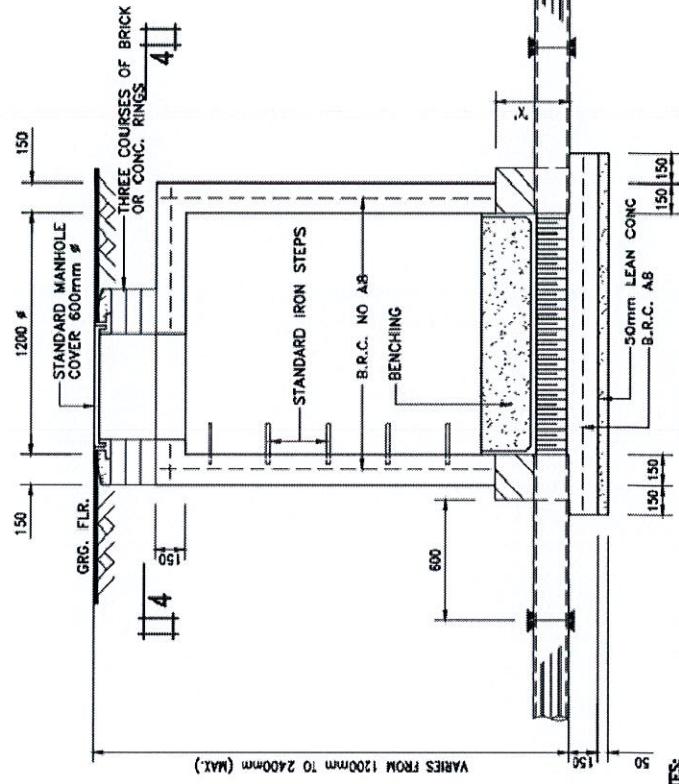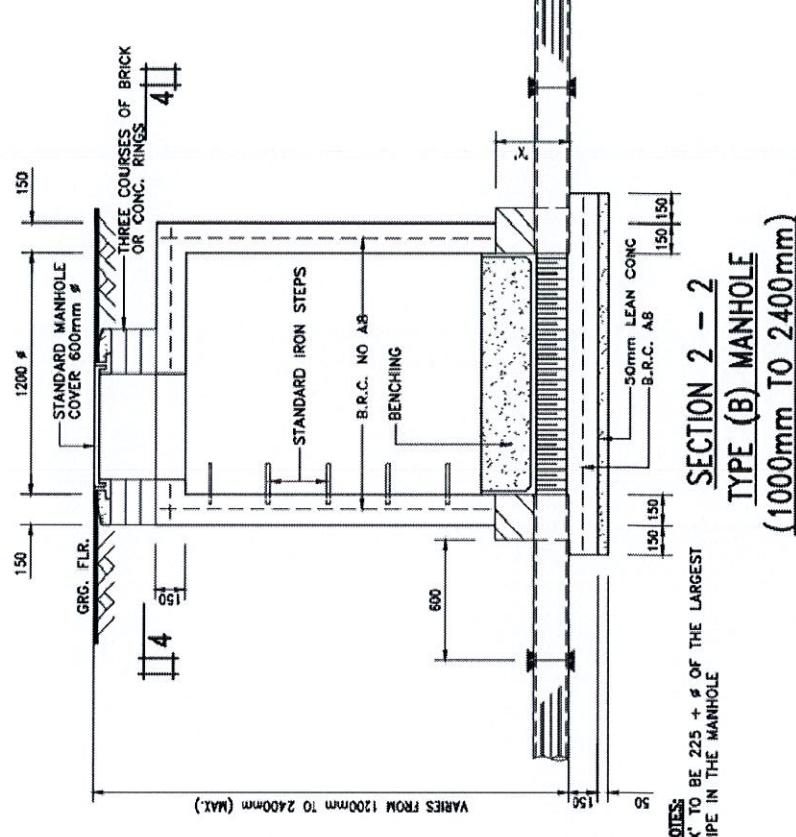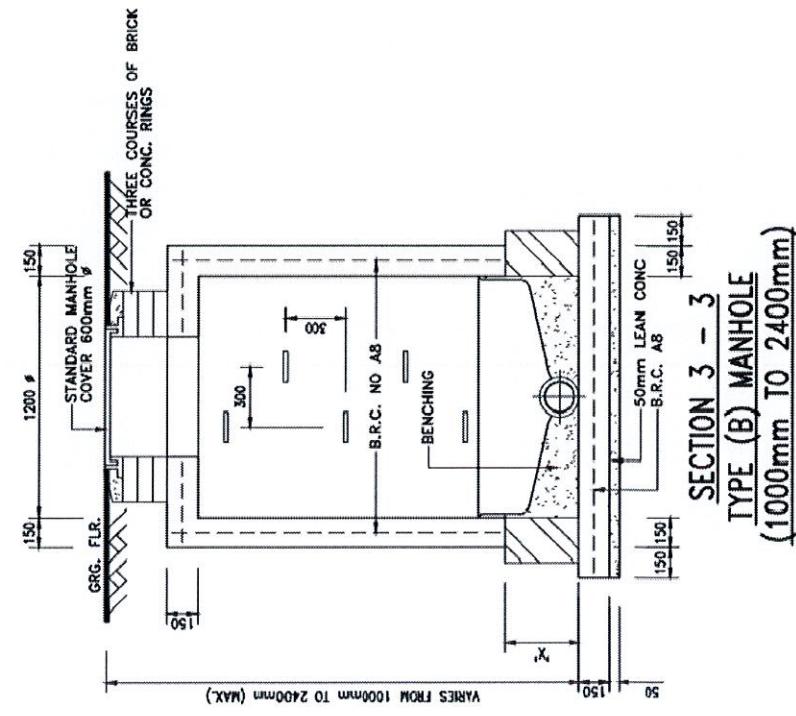


DRAWING NO ;  
DCQ50244/SEWERAGE  
/BQ3/01

NOTES:  
YOU CAN MAKE ALL  
NECESSARY AND  
REASONABLE  
ASSUMPTIONS WHERE  
APPLICABLE

<b>LEGEND:-</b>	<b>PROPOSED FIRE HYDRANT</b>
	6mm THK 200mm Ø M.S. PIPE
	PROPOSED 100mm Ø MSCL PIPE

MH SEWERAGE MH

6.7m WIDE BITUMINOUS CARRIAGeway


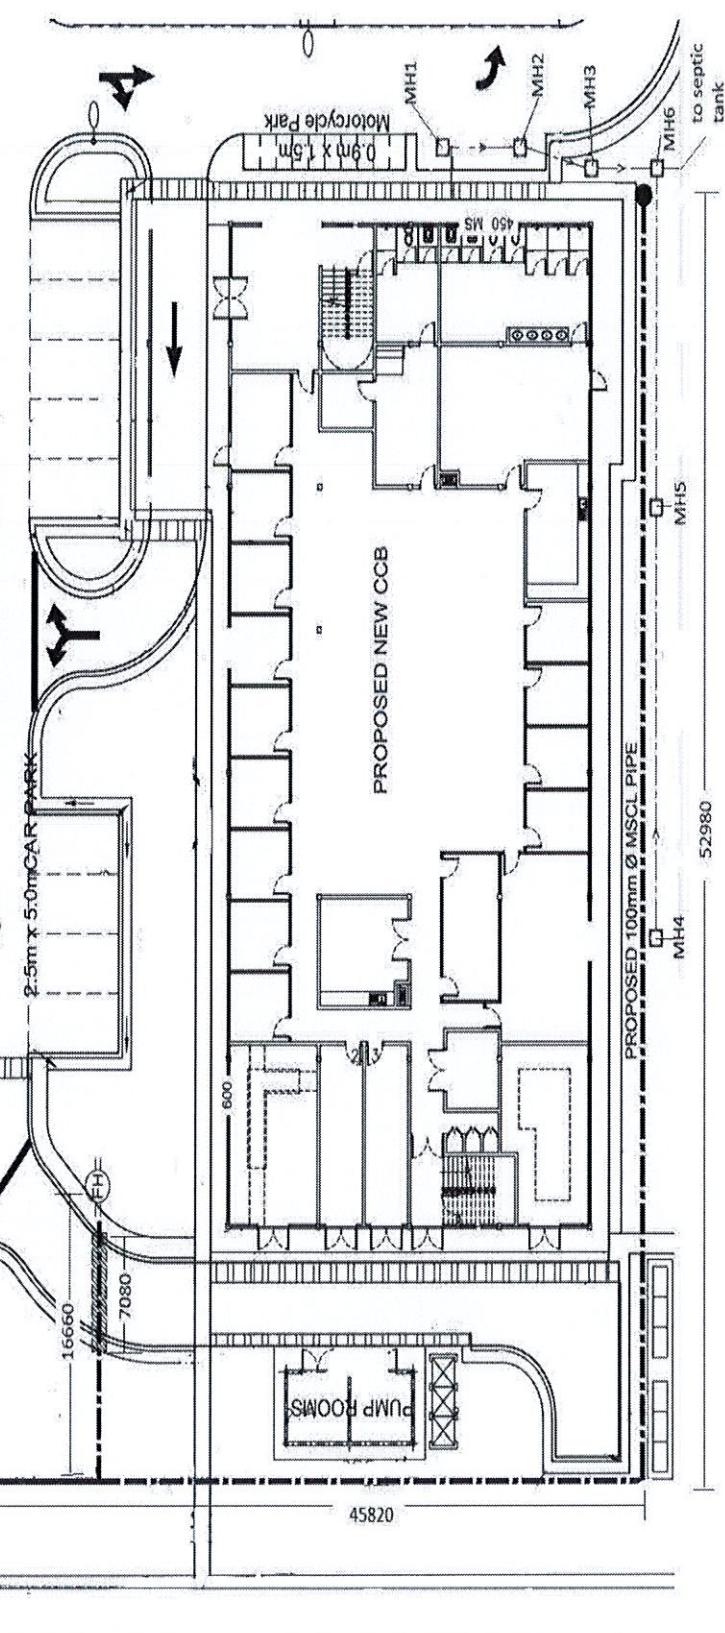


PROJECT TITLE;  
NEW CCB

DRAWING TITLE;  
SEWERAGE WORKS,  
WATER RETICULATION  
SYSTEM LAYOUT  
PLAN AND DETAILS


DRAWING NO :  
DCQ50244/SEWERAGE  
/BQ3/02

MANHOLE	GROUND LEVEL	MANHOLE INVERT LEVEL
MH1	4.25	2.75
MH2	4.25	2.83
MH3	4.25	2.96
MH4	4.25	2.71
MH5	4.25	2.8
MH6	4.25	2.98

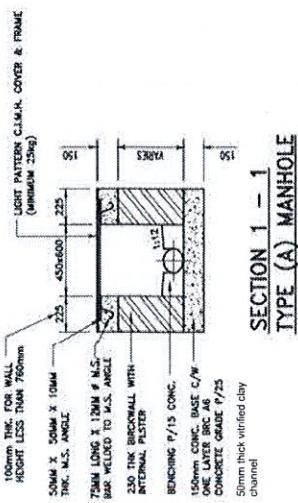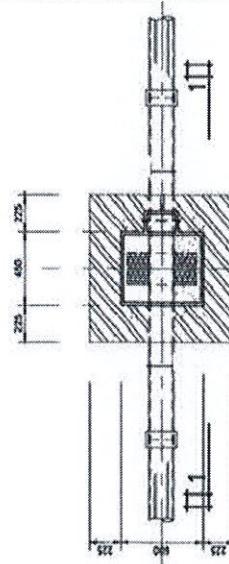

DETAILS OF MANHOLE  
TYPE (A)

<p><b>NOTES:</b></p> <ol style="list-style-type: none"> <li>All brickworks shall be 225mm thick common brick unless otherwise stated.</li> <li>Assumption shall be made if the information is not sufficient.</li> <li>Chain links fencing - - -</li> </ol>									
<b>DOOR SCHEDULE</b>									
<table border="1"> <tr> <td>D1</td> <td>1800mm x 2100mm</td> <td>Timber flush door</td> </tr> <tr> <td>D2</td> <td>2000mm x 2100mm</td> <td>Timber flush door</td> </tr> <tr> <td>D3</td> <td>3150mm x 2100mm</td> <td>Timber flush door</td> </tr> </table>	D1	1800mm x 2100mm	Timber flush door	D2	2000mm x 2100mm	Timber flush door	D3	3150mm x 2100mm	Timber flush door
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D2	2000mm x 2100mm	Timber flush door							
D3	3150mm x 2100mm	Timber flush door							
<b>WINDOW SCHEDULE</b>									
<table border="1"> <tr> <td>W1</td> <td>2100mm x 1200mm</td> <td>Louvers</td> </tr> </table>	W1	2100mm x 1200mm	Louvers						
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<b>RENOVATION TABLE</b>									
<table border="1"> <tr> <td>1. D1 are to be replaced with 1800mm x 2100mm Panel Door.</td> </tr> <tr> <td>2. W1 are to be replaced with 1200mm x 1200mm Aluminium Casement Window.</td> </tr> </table>	1. D1 are to be replaced with 1800mm x 2100mm Panel Door.	2. W1 are to be replaced with 1200mm x 1200mm Aluminium Casement Window.							
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<b>TAJUK PROJEK:</b> KERJA-KERJA PENGUBAHSUAIAN RUMAH BUNGLOW DI BEHRANG SENTRAL									
<b>POLITEK</b> MALAYSIA									
<b>DRAWING TITLE:</b> DEMOLISH & RENOVATION FENCING & GATE									
<b>SCALE:</b> 1 : 500									
<b>NO. LUKISAN :</b> DCQ50244/FENCING&DEMOLISH/BQ4/01									

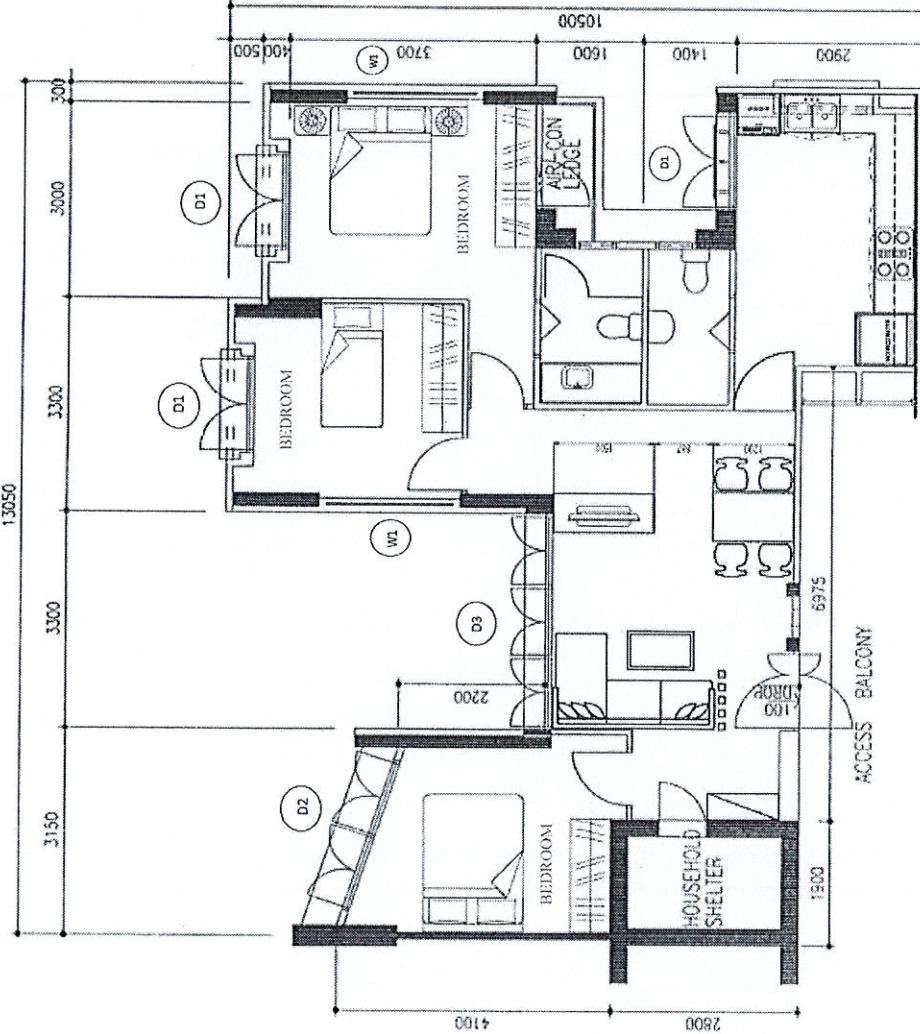

<p><b>NOTES:</b></p> <ol style="list-style-type: none"> <li>1. 2100mm high 63x63 SWG 10 G.I PVC Coated Chain Link Fencing.</li> <li>2. 3 nos Barb wire complete barbed tape with 600mm high.</li> <li>3. 50x50 x 6mm M.S 'L' Angle Post @ 3000mm internal</li> <li>4. 300x300x600mm depth concrete footing (1:3:5)</li> <li>5. In situ concrete grade 20 with size 150 x 200mm as a concrete kerb complete with one layer of BRC A7</li> <li>6. 2400mm Wide Double Leaf Vehicular Access Gate complete with horizontal &amp; vertical bracing CHS 48.3 x 4mm.</li> <li>7. 600x600x1300mm depth concrete footing for gate post (1:3:5)</li> </ol>
<b>TAJUK PROJEK:</b> <b>KERJA-KERJA PENGUBAHSUAIAN</b> <b>RUMAH BUNGLOW</b> <b>DI BEHRANG SENTRAL</b>

**POLITEKNIK**  
MALAYSIA

DRAWING TITLE:  
FENCING & GATE DETAILS

SCALE:  
NOT TO SCALE

NO. LUKISAN :  
DCQ5024/FENCING&DEMOLISH/BQ4/02

